


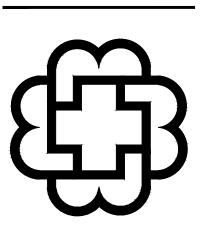

KALAMAZOO OFFICE 612 South Park Street Kalamazoo, Michigan 49007


GRAND RAPIDS OFFICE

Grand Rapids, Michigan 49503



KEY PLAN PLAN NORTH

ALL PLANS, ELEVATIONS,
SCHEDULES, ETC. REFERENCE
PLAN NORTH. ACTUAL
BUILDING ORIENTATION ON
THE "TRUE NORTH"
DIFFERS FROM THE
DRAWING PLAN NORTH.
REFER TO COVER SHEET AND
SITE PLAN FOR TRUE
ORIENTATION OF THE

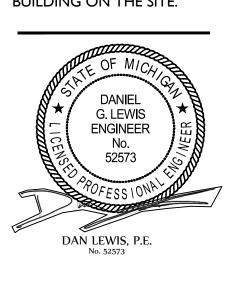

V. MAIN ST. - NEW PRIMARY CARE BUILDING

RONSON HEALTHCARE GROUP
SHTEMO TOWNSHIP, MICHIGAN 49009

JED
AY 23, 2019
NECT NILIMBER

PROJECT NUMBER

SHEET TITLE

TITLE PAGE

T1. CONST. DOCUMENTS

This drawing, as an instrument of service, is owned

by the diekema hamann architecture, inc.
Reproduction of this document is prohibited without express authorization from the architect.

© 2019 DIEKEMA|HAMANN ARCHITECTURE

DAN LEWIS. P.E. DATE

BRONSON PRIMARY CARE PARTNERS WEST MAIN 6220 WEST MAIN SECTION 14 OSHTEMO TOWNSHIP KALAMAZOO COUNTY, MI

SITE DEVELOPMENT PLANS MAY 23, 2019

ISSUED FOR: SITE PLAN SUBMITTAL

SHEET INDE	EX
No.	SHEET TITLE
C1.0	EXISTING CONDITIONS
C2.0	DEMOLITION PLAN
C3.0	SITE LAYOUT & UTILITY PLAN
C4.0	GRADING & SESC PLAN
C5.0	DETAILS
L1.0	LANDSCAPE PLAN
ES0.1	ELECTRICAL SITE PLANS
A1.0 - A1.3	FLOOR PLANS
A3.1 - A3.2	EXTERIOR BUILDING ELEVATIONS

No.	ISSUED FOR:	DATE:	BY:
0	SITE PLAN SUBMITTAL	05/02/2019	DL
1	ISSUED FOR BIDS	05/16/2019	DL
2	OSTHEMO COMMENTS	05/23/2019	DL
3	•	•	
4	•	•	
5	•	•	
6	•	•	
7	•	•	
8	•	•	
_			

OWNER/APPLICANT:


BRONSON HEALTHCARE GROUP GREG MILLIKEN 601 JOHN STREET, BOX 9 KALAMAZOO, MI 49007

CIVIL ENGINEER:


AR ENGINEERING, LLC. 4664 CAMPUS DRIVE, SUITE 106 KALAMAZOO, MI 49008 TEL. (269) 207-4438 FAX. (866) 569-0604


AR Engineering

ALL UTILITIES AS SHOWN ARE APPROXIMATE LOCATIONS DERIVED FROM ACTUAL MEASUREMENTS AND AVAILABLE RECORDS. THEY SHOULD NOT BE INTERPRETED TO BE EXACT LOCATION NOR SHOULD IT BE ASSUMED THAT THEY ARE THE ONLY UTILITIES IN THE AREA. FIELD WORK PERFORMED BY: PREIN & NEWHOF

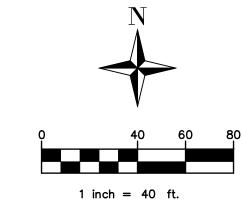




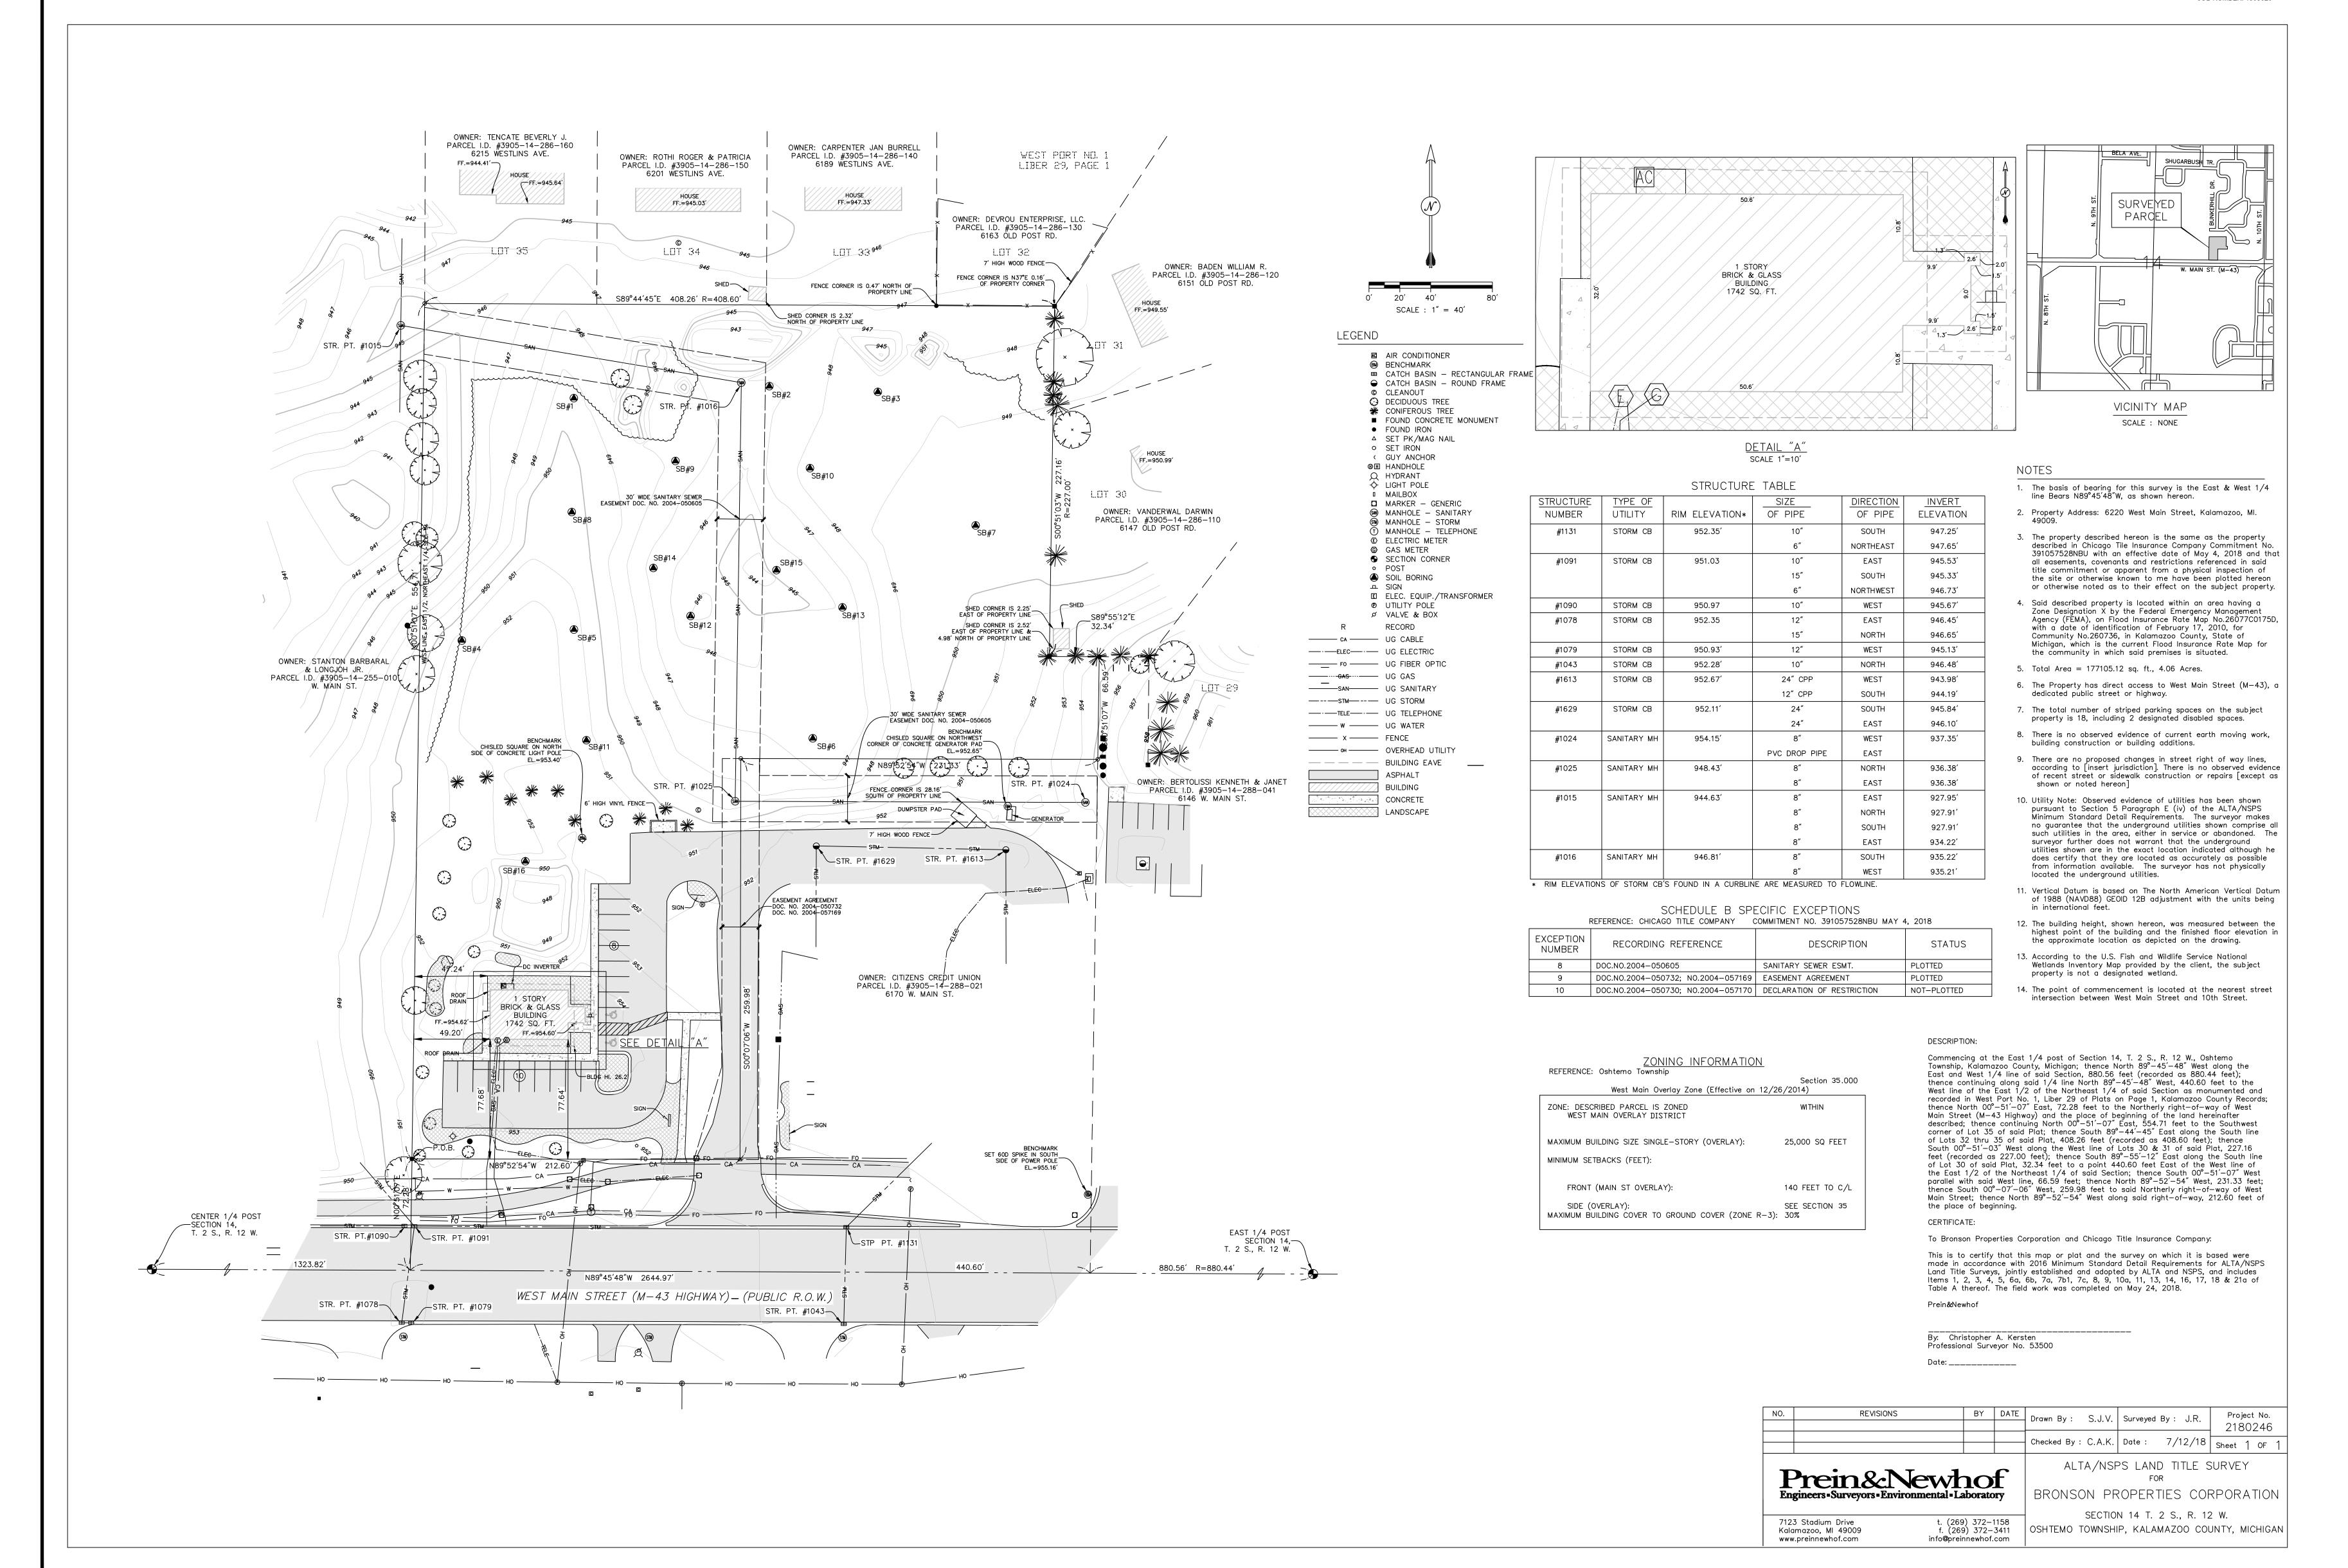

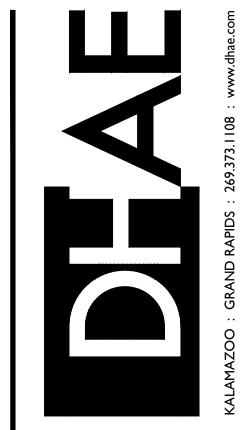

KALAMAZOO OFFICE 612 South Park Street Kalamazoo, Michigan 49007

GRAND RAPIDS OFFICE 15 Ionia SW - Suite 330 Grand Rapids, Michigan 49503

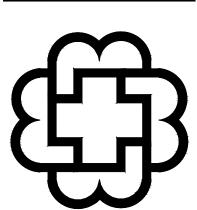

PLAN PLAN NORTH

ALL PLANS, ELEVATIONS, SCHEDULES, ETC. REFERENCE PLAN NORTH. ACTUAL BUILDING ORIENTATION ON THE "TRUE NORTH" DIFFERS FROM THE DRAWING PLAN NORTH. REFER TO COVER SHEET AND SITE PLAN FOR TRUE ORIENTATION OF THE BUILDING ON THE SITE.

MAIN ST. - NEW PRIMARY CARE BUILDING
ONSON HEALTHCARE GROUP
HEMO TOWNSHIP, MICHIGAN 49009

REVISIONS

SITE PLAN SUBMITTAL 05/02/2019
ISSUED FOR BIDS 05/16/2019
OSHTEMO COMMENTS 05/23/2019

MAY 23, 2019

PROJECT NUMBER

0015.01

EXISTING CONDITIONS

SHEET NUMBER

C1. CONST. DOCUMENTS

This drawing, as an instrument of service, is owned by the diekema hamann architecture, inc.
Reproduction of this document is prohibited without express authorization from the architect.

© 2019 DIEKEMAJHAMANN ARCHITECTURE

DEMOLITION NOTES


- ALL WORK SHALL CONFORM TO ALL LOCAL, STATE AND FEDERAL LAWS, RULES AND REGULATIONS IN FORCE AT TIME OF CONSTRUCTION.
- THE GENERAL CONTRACTOR SHALL BE RESPONSIBLE FOR OBTAINING ALL PERMITS, PERMIT COSTS, TAP FEES, METER DEPOSITS, PERMANENT UTILITY APPLICATIONS, BONDS, AND OTHER FEES REQUIRED FOR PROPOSED WORK. THIS SHALL INCLUDE, BUT SHALL NOT BE LIMITED TO THOSE REQUIRED BY THE CITY OF KALAMAZOO AND KALAMAZOO COUNTY.
- CONTACT "811" FOR LOCATION OF UNDERGROUND UTILITIES A MINIMUM OF 48 HOURS BEFORE COMMENCING EXCAVATION WORK. THIS DOES NOT RELIEVE THE CONTRACTOR OF THE RESPONSIBILITY OF NOTIFYING UTILITY OWNERS WHO ARE NOT PART OF THE "811-MISS DIG" ALERT SYSTEM. THE CONTRACTOR SHALL


CONDUCT HIS OPERATIONS IN A MANNER AS TO ENSURE THAT THOSE UTILITIES

- DEMOLISH & REMOVE ALL EXISTING SITE FEATURES AS REQUIRED.
- ALL SOIL EROSION CONTROL MEASURES SHALL BE IN PLACE PRIOR TO DEMOLITION.

NOT REQUIRING RELOCATION WILL NOT BE DISTURBED.


- ALL EXCAVATION SHALL BE IN ACCORDANCE WITH THE TECHNICAL SPECIFICATIONS AND GEOTECHNICAL REPORT.
- ALL EXISTING ELEVATIONS ARE TO BE VERIFIED AND ACCEPTED AS SHOWN PRIOR TO COMMENCEMENT OF WORK.
- CONTRACTOR SHALL TAKE PRECAUTIONS TO AVOID TRACKING SOIL ONTO ADJACENT ROADWAYS. CONTRACTOR SHALL SWEEP IMMEDIATELY IF OCCURS.
- ANY DISTURBED AREA WHICH WILL BE LEFT UNWORKED 15 DAYS OR LONGER MUST BE SEEDED TO ESTABLISH VEGETATION FOR TEMPORARY STABILIZATION. BASINS TO BE SEEDED AND MULCH BLANKETS APPLIED IMMEDIATELY TO PROVIDE A STABLE BASE AND AVOID EXCESSIVE EROSION.
- 10. REVIEW ALL THE REMOVALS AND PROTECTION WITH OWNER PRIOR TO COMMENCING CONSTRUCTION. INSTALL TEMPORARY SNOW FENCE AROUND ALL TREES REQUIRING PROTECTION. SNOW FENCE SHALL BE PLACED AT EDGE OF DRIP
- SAWCUT ALL CURB, SIDEWALK, AND PAVEMENTS PRIOR TO REMOVAL. ADDITIONAL SAWCUT MAY BE NECESSARY PRIOR TO REPLACEMENT TO ENSURE CLEAN EDGE.
- 12. ALL REMOVALS SHALL BE TAKEN OFF-SITE AND DISPOSED OF PROPERLY. NO STOCKPILE OR BURNING OF DEBRIS IS ALLOWED.
- 13. ALL REMOVALS SHALL BE TO THE LIMITS INDICATED ABOVE UNLESS OTHERWISE DIRECTED BY THE ENGINEER. UNAUTHORIZED REMOVALS AND SUBSEQUENT REPLACEMENT SHALL BE AT THE CONTRACTOR'S EXPENSE.
- 14. REMOVE, STORE, AND RESET ANY EXISTING SIGNS AS DIRECTED BY THE ENGINEER/OWNER.
- REMOVE ALL TREES TO THE CLEARING LIMITS AS SHOWN. REMOVE ALL EXISTING TREES, STUMPS AND BRUSH FROM THE SITE AS NECESSARY TO CONSTRUCT THE IMPROVEMENTS.
- 16. BACKFILL EXCAVATED AREAS WITH CLEAN GRANULAR FILL COMPACTED TO 95% OF THE MATERIAL UNIT WEIGHT BY MODIFIED PROCTOR.
- CONTROL SHALL BE MAINTAINED OVER THE SITE AND OPERATION TO ELIMINATE HAZARDS TO THE PUBLIC. NAILS OR OTHER TIRE PUNCTURING ITEMS SHALL NOT BE DROPPED ON STREETS, ALLEYS AND ADJACENT PROPERTY. PUBLIC STREETS, CURBS AND SIDEWALKS SHALL BE PROTECTED FROM DAMAGE. THE PERSON ENGAGED IN THE DEMOLITION WORK SHALL BE LIABLE FOR ANY AND ALL DAMAGE TO CURBS, STREETS, SIDEWALKS AND OTHER PUBLIC OR PRIVATE PROPERTY AND FOR ANY BODILY INJURY OCCURRING AS A RESULT OF THE DEMOLITION WORK.

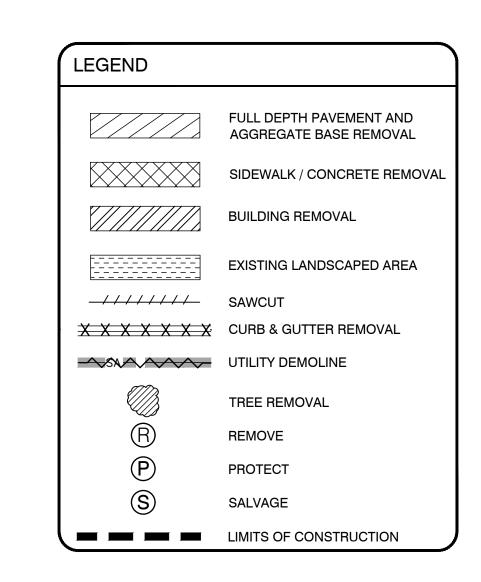

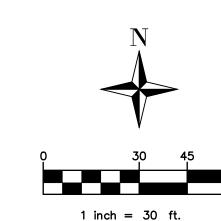





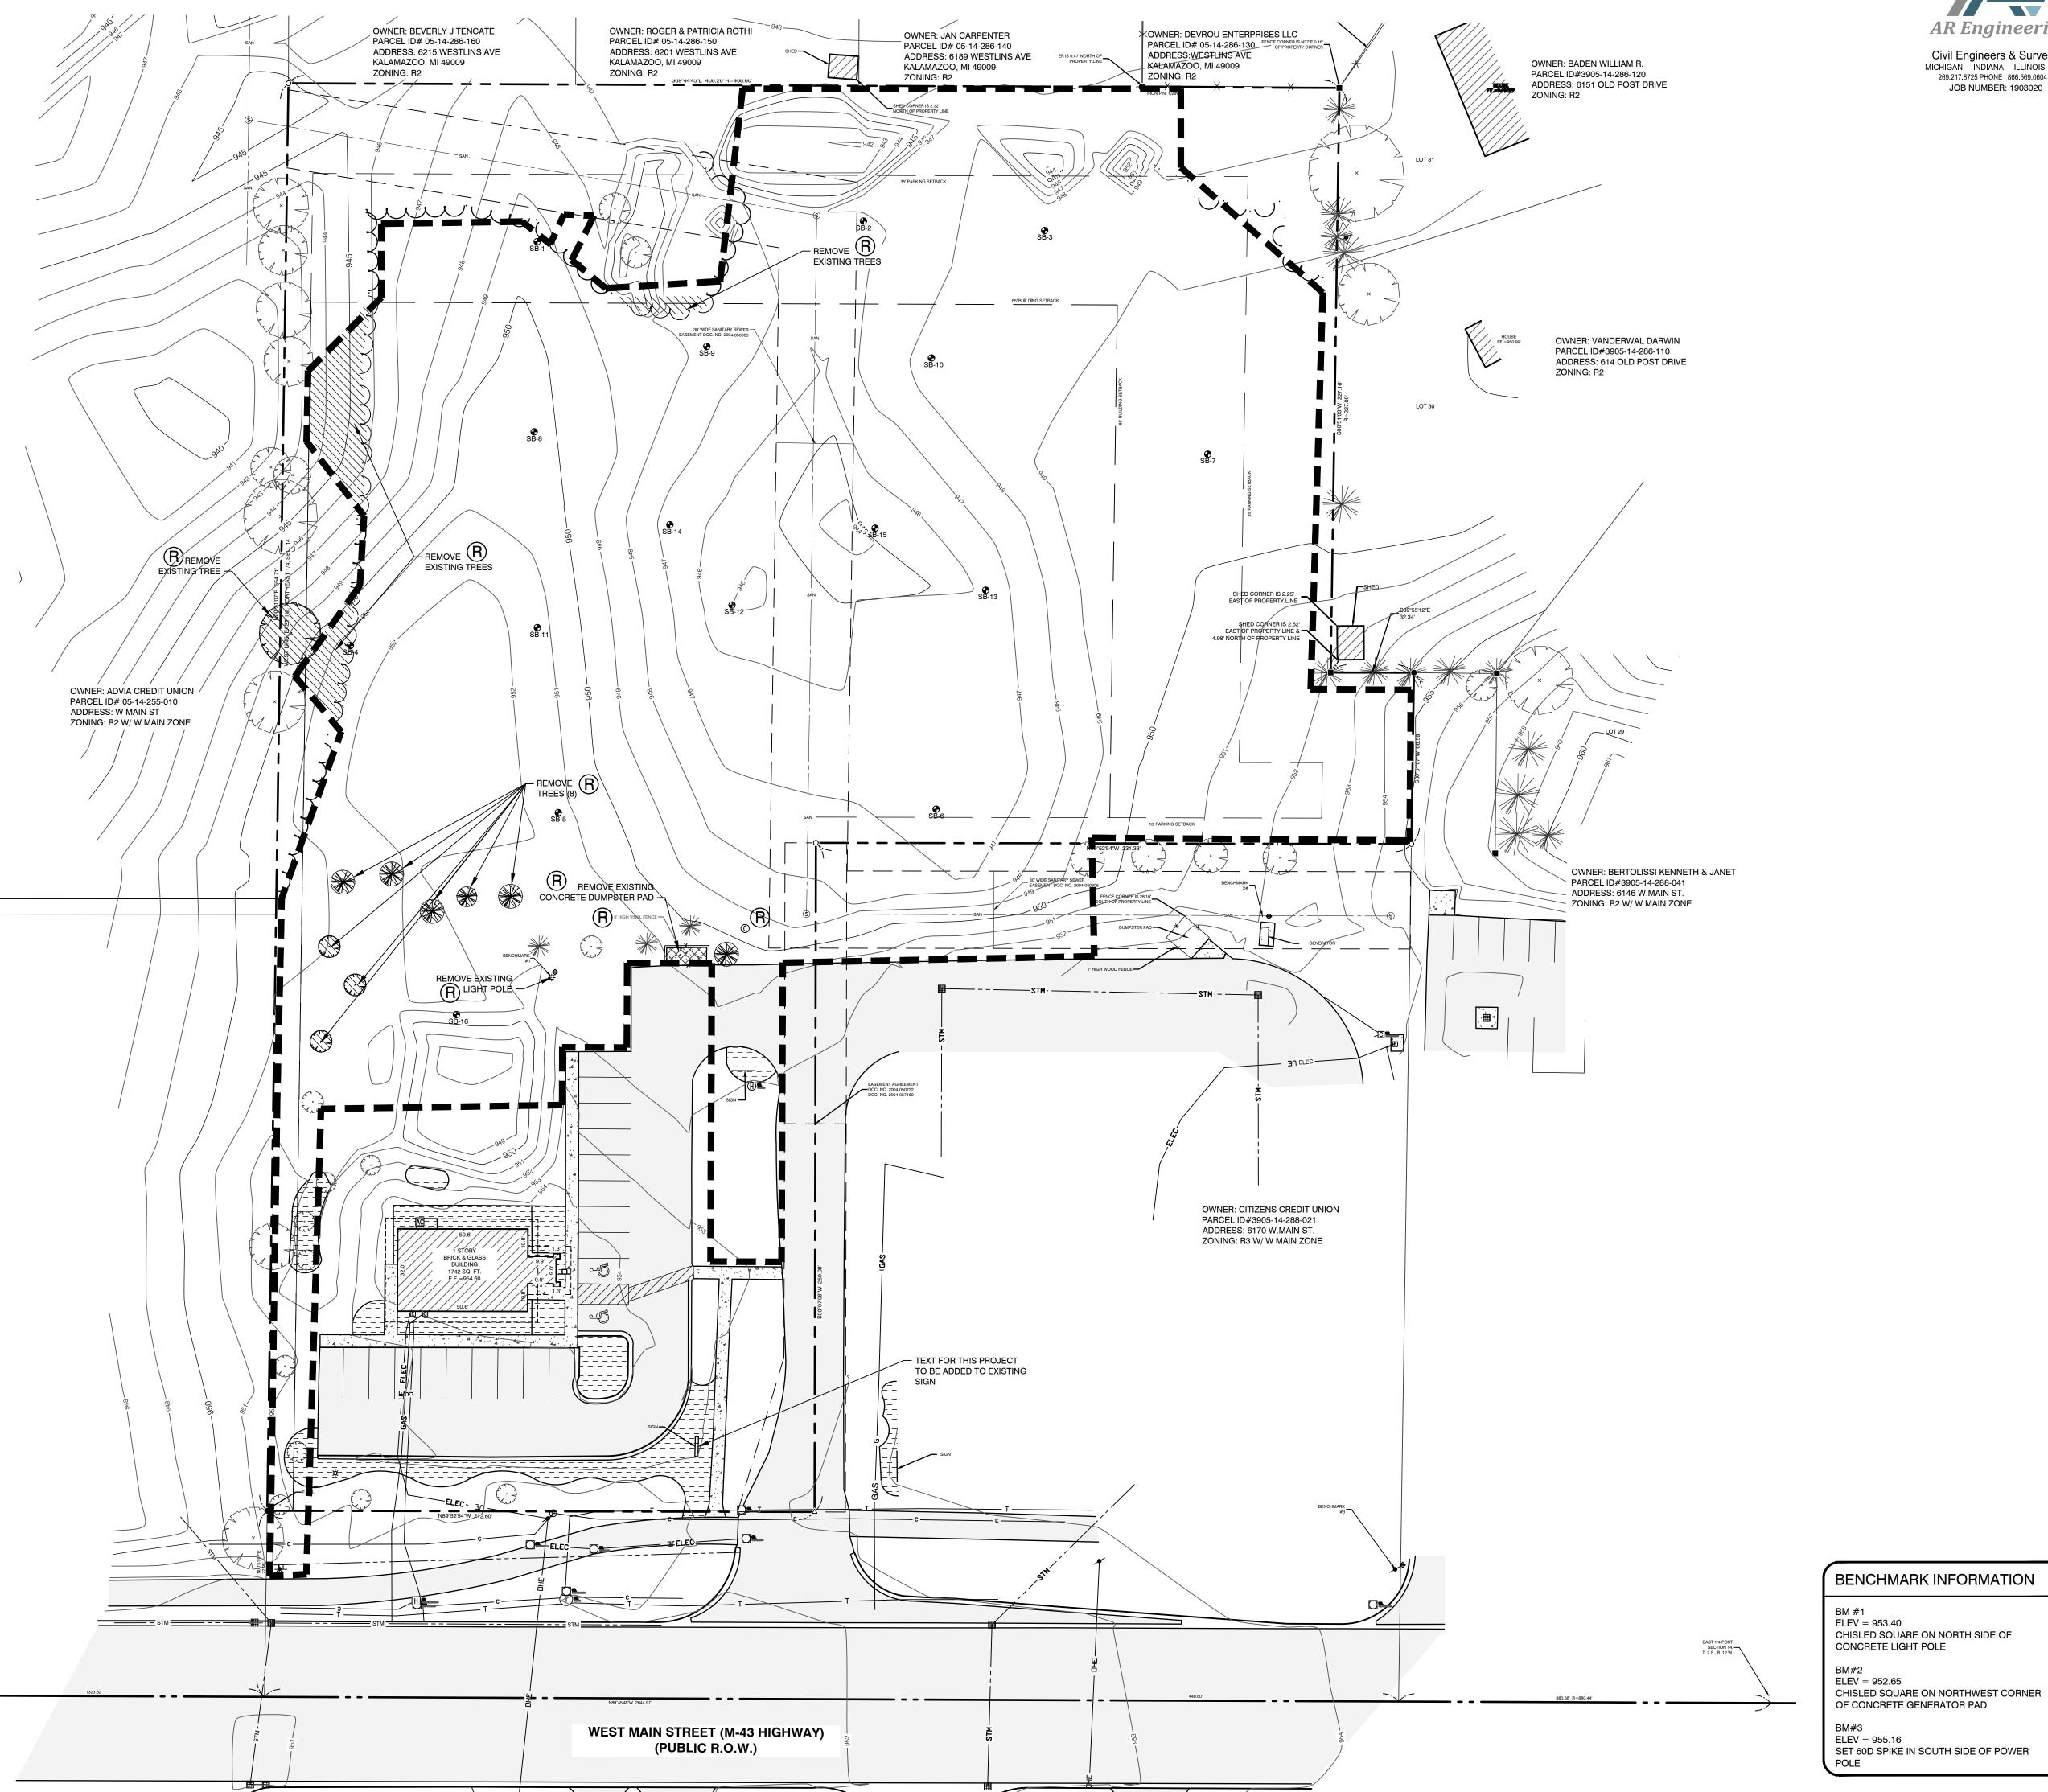




ALL UTILITIES AS SHOWN ARE APPROXIMATE LOCATIONS DERIVED FROM ACTUAL MEASUREMENTS AND AVAILABLE RECORDS. THEY SHOULD NOT BE INTERPRETED TO BE EXACT LOCATION NOR SHOULD IT BE ASSUMED THAT THEY ARE THE ONLY UTILITIES IN THE AREA. FIELD WORK PERFORMED BY: PREIN & NEWHOF


KALAMAZOO OFFICE 612 South Park Street Kalamazoo, Michigan 49007

GRAND RAPIDS OFFICE 15 Ionia SW - Suite 330

Grand Rapids, Michigan 49503

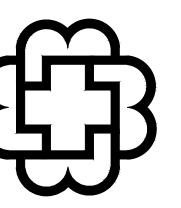

ALL PLANS, ELEVATIONS, SCHEDULES, ETC. REFERENCE PLAN NORTH. ACTUAL BUILDING ORIENTATION ON THE "TRUE NORTH" DIFFERS FROM THE DRAWING **PLAN NORTH**. REFER TO COVER SHEET AND SITE PLAN FOR TRUE ORIENTATION OF THE BUILDING ON THE SITE.

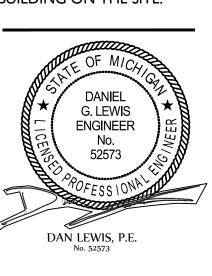

OSHTEMO COMMENTS 05/23/2019

MAY 23, 2019 PROJECT NUMBER

19015.01

DEMOLITION PLAN

C2.0 CONST. DOCUMENTS

This drawing, as an instrument of service, is owned

by the diekema hamann architecture, inc.
Reproduction of this document is prohibited without

© 2019 DIEKEMA|HAMANN ARCHITECTURE

express authorization from the architect.

GENERAL NOTES SITE PLAN NOTES ALL WORK SHALL CONFORM TO ALL LOCAL, STATE AND FEDERAL LAWS, RULES AND REGULATIONS IN FORCE AT A. 12' x 24' CONCRETE PAD FOR DUMPSTER W/ VINYL ENCLOSURE 6' TALL TIME OF CONSTRUCTION. MIN. SEE CONC PAVEMENT DETAIL ELECTRICAL WORK SHALL BE PERFORMED BY A STATE OF MICHIGAN LICENSED ELECTRICIAN ACCORDING TO THE B. 18'X36' RELOCATED CONCRETE DUMPSTER PAD N.F.P.A. NATIONAL ELECTRICAL CODE AS MODIFIED BY THE STATE OF MICHIGAN. FURNISH AND INSTALL ALL MATERIALS AND LABOR TO PROVIDE A COMPLETE WORKING SYSTEM. C. INTEGRAL CURB/WALK (SEE DETAIL SHEET). ALL PLUMBING WORK SHALL BE PERFORMED BY A STATE OF MICHIGAN LICENSED PLUMBER ACCORDING TO THE D. 40 SQFT MONUMENT SIGN TO BE APPROVED SEPARATELY AT LATER INTERNATIONAL PLUMBING CODE AS MODIFIED BY THE STATE OF MICHIGAN AND LOCAL HEALTH DEPARTMENT. FURNISH AND INSTALL ALL MATERIALS AND LABOR TO PROVIDE A FULL WORKING SYSTEM. E. BOLLARDS WITH DECORATIVE BOLLARD SLEEVE (SEE DETAIL SHEET) ALL MECHANICAL WORK SHALL BE PERFORMED ACCORDING TO THE INTERNATIONAL MECHANICAL CODE AS MODIFIED BY THE STATE OF MICHIGAN AND THE MICHIGAN ENERGY CODE. FURNISH AND INSTALL ALL MATERIALS F. 6' WIDE LIMESTONE SIDEWALK 8" DEEP AND LABOR TO PROVIDE A FULL WORKING SYSTEM. G. PROPOSED HVAC CONDENSERS GENERATOR AND TRANSFORMER ALL WORK SHALL CONFORM TO THE MICHIGAN HANDICAPPED ACCESSIBILITY CODE AND THE AMERICANS WITH (REFER TO MEP DRAWINGS FOR ADDITIONAL INFORMATION) DISABILITIES ACT. H. LOADING AREA WATER SERVICE PRESSURE TESTING AND CHLORINATION SHALL BE PER MDEQ AND CITY OF KALAMAZOO I. TWO-WAY YARD CLEANOUT SANITARY SEWER INSTALLATION AND TESTING MUST MEET THE REQUIREMENTS OF CITY OF KALAMAZOO AND THE J. SEWER LATERAL. COORDINATE CONNECTION WITH PLUMBING PLANS MICHIGAN DEPT. OF ENVIRONMENTAL QUALITY. K. CONNECT TO EXISTING SEWER LEAD. COORDINATE WITH ALL REGULATORY SIGNAGE (IF SPECIFIED) SHALL BE PER THE MICHIGAN DEPARTMENT OF TRANSPORTATION MUNICIPALITY. I.E. ± 935.39 PRIVATE UTILITIES (ELECTRIC,GAS,FIBER,ETC) (SEE MEP DRAWINGS . THE GENERAL CONTRACTOR SHALL BE RESPONSIBLE FOR OBTAINING ALL PERMITS, PERMIT COSTS, TAP FEES, FOR ADDITIONAL INFORMATION) METER DEPOSITS, PERMANENT UTILITY APPLICATIONS, BONDS, AND OTHER FEES REQUIRED FOR PROPOSED M. 12" FLARED END SECTION WITH RIPRAP AND REFUSE SCREEN . CONTACT "MISS DIG" AT 1-800-482-7171 FOR LOCATION OF UNDERGROUND UTILITIES A MINIMUM OF 48 HOURS N. CONNECT TO EXISTING WATER MAIN. COORDINATE CONNECTION BEFORE COMMENCING EXCAVATION WORK. THIS DOES NOT RELIEVE THE CONTRACTOR OF THE RESPONSIBILITY OF WITH CITY OF KALAMAZOO. NOTIFYING UTILITY OWNERS WHO ARE NOT PART OF THE "MISS DIG" ALERT SYSTEM. THE CONTRACTOR SHALL CONDUCT HIS OPERATIONS IN A MANNER AS TO ENSURE THAT THOSE UTILITIES NOT REQUIRING RELOCATION WILL O. SANITARY CLEANOUT NOT BE DISTURBED. P. BUILDING SIGN TO BE APPROVED AT A LATER DATE ANY SANITARY SEWER, SANITARY SEWER SERVICE LEADS, WATER MAIN, WATER SERVICES, OR STORM SEWER WHICH IS DAMAGED BY THE CONTRACTOR DURING HIS OPERATIONS SHALL BE REPAIRED TO THE OWNERS Q. STOP SIGN SATISFACTION, AND AT THE CONTRACTORS EXPENSE. IF ANY ELEMENTS OF THE SANITARY SEWER SYSTEM ARE DAMAGED AND NEED REPAIRED, IT MUST MEET CITY OF KALAMAZOO SPECIFICATIONS. R. IRRIGATION LINE (SEE IRRIGATION PLAN FOR CONTINUANCE) . THE ELECTRICAL CONTRACTOR IS RESPONSIBLE FOR THE ELECTRICAL TRANSFORMER PAD PER THE UTILITY S. AT-GRADE RAMP(SEE GRADING PLAN) COMPANY SPECIFICATIONS. LIGHT POLE LOCATIONS(SEE ELECTRICAL PLAN FOR ADDITIONAL 3. THE TELEPHONE UTILITY COMPANY SHALL PROVIDE UNDERGROUND TELEPHONE TO THE BUILDING AT THE OWNERS INFORMATION) REMOTE FDC CONNECTION (48" IN HEIGHT AND HAVE LOCKING KNOX 4. REFER TO ELECTRICAL DRAWINGS FOR UNDERGROUND ELECTRICAL REQUIREMENTS FOR SITE LIGHTING & SITE STORZGUARD WITH 30° OFFSET AND LOCKING CAP) WITH 12" x 24" DETAILS SHEETS FOR THE FIXTURE AND & POLE SPECIFICATIONS. RED REFLECTIVE BACKGROUND FDC WHITE LETTERING MOUNTED ON SIGN POST 6'-8" TO BOTTOM OF SIGN 5. DESIGN, INSTALLATION AND SPECIFICATION FOR IMPROVEMENTS RELATED TO GAS, TELEPHONE, ELECTRIC AND CABLE TELEVISION SERVICES SHALL BE COORDINATED BY THE CONTRACTOR. V. 2' STONE MAINTENANCE STRIP AROUND ENTIRE BUILDING (SEE LANDSCAPE PLAN FOR ADDITIONAL INFORMATION) 16. CONTRACTOR SHALL COORDINATE TELEPHONE, ELECTRIC, AND CABLE TELEVISION CONDUITS WITH THE APPROPRIATE UTILITY PRIOR TO PAVEMENT INSTALLATION. W. 8" ROOF DRAIN . CONTRACTOR IS TO UNCOVER AND CONFIRM ALL TAP LOCATIONS. LOCATION DISCREPANCIES ARE TO BE BROUGHT X. 6" WHITE CROSSWALK TO THE ENGINEERS ATTENTION FOR RESOLUTION. Y. 20 SQFT DIRECTIONAL SIGN 18. THE CONTRACTOR IS TO PROVIDE THE WATER SERVICE PIPING FROM THE BUILDING TO THE EXISTING MAIN. THE CONTRACTOR SHALL MAKE THE CONNECTION TO THE SHUT OFF VALVE, THE CONTRACTOR SHALL COORDINATE SIGN: FIRE LANE NO STOPPING STANDING OR LOADING, WHITE SERVICES WITH THE CITY OF KALAMAZOO. BACKGROUND WITH RED LETTERING (6'-8" TO BOTTOM OF SIGN) CONTRACTOR/OWNER SHALL OBTAIN UTILITY CONNECTION PERMITS AND SETTLE APPLICABLE UTILITY AA. ELECTRIC LINE FROM BUILDING TO SIGN ASSESSMENTS PRIOR TO EXTENSION OF PUBLIC UTILITIES ONSITE. BB. KNOX BOX LOCATIONS 0. MANHOLE AND CATCH BASIN STRUCTURES SHALL BE PRECAST AND HAVE A MAXIMUM OF 2 ADJUSTING RINGS FOR FINISH GRADE ADJUSTMENT. STORM STRUCTURES MUST ALL HAVE A SUMP OF TWO FEET. CC. 33 LF 3" PE STORM FORCE MAIN OUTLET. PROVIDE 4' OF COVER . ALL WATER MAIN TO HAVE A BURIAL DEPTH AS REQUIRED BY THE MICHIGAN DEPARTMENT OF ENVIRONMENTAL DD. 6" WATER VALVE QUALITY FOR THE SPECIFIC REGION OF WORK IN THE CITY OF KALAMAZOO. 22. DEMOLISH & REMOVE ALL EXISTING SITE FEATURES AS REQUIRED. 23. THE CONTRACTOR SHALL REVIEW THE GEOTECHNICAL REPORT

GENERAL NOTES

DIMENSIONS TAKE PRECEDENCE OVER SCALE. CONTRACTOR

IF ANY ERRORS, DISCREPANCIES, OR OMISSIONS BECOME APPARENT, THESE SHALL BE BROUGHT TO THE ATTENTION OF THE ARCHITECT/ ENGINEER PRIOR TO CONSTRUCTION OF ANYTHING AFFECTED SO THAT CLARIFICATION OR REDESIGN

ALL CURB RADII AND DIMENSIONS ARE TO FACE OF CURB. CURB TO BE PROVIDED WHERE SHOWN AND INTEGRAL WITH

SLOPE GRADES UNIFORMLY BETWEEN ELEVATIONS SHOWN.

GROSS SITE AREA: 177,106 SQ. FT. PRIMARY CARE = 12,706 SQ. F FASTCARE= 1584 SQ. FT. BUILDING COVERAGE = 8%

REQUIRED= 8,900 SQ. FT. USEABLE FLOOR AREA / 150

RIM = 949.00

8" HDPE N

8" HDPE W

8" HDPE SE

12" HDPE E

RIM = 948.25

RIM = 938.67

BTM = 933.17

RIM = 938.67

BTM = 933.17

12" HDPE N

12" HDPE N

6" PVC SW, NE

INLET-13, 2' DIA, BEEHIVE RIM = 950.43

CB-14, 2' DIA, EJIW 7060

SUMPS, INLETS DO NOT

* ALL CATCH BASINS HAVE 2'

6" PVC SW,NE

8" HDPE W

8" HDPE S 12" HDPE NE 944.50

944.25

934.17

NOMINAL GRADING, SLOPE SIDEWALKS AWAY FROM BUILDING

TO VERIFY ALL DIMENSIONS IN FIELD.

SIDEWALK AT PAVING EDGE.

OPEN SPACE = 57%

6. BUILDING HEIGHT = 30.75

59 SPACES REQUIRED

MAXIMUM OF 66 SPACES

STORM STRUCTURE DATA

PARKING CALCS

RIM = 950.08

12" HDPE N

12" HDPE S

12" HDPE SW

12" HDPE NE

RIM = 949.50

12" HDPE SW

12" HDPE SE

12" HDPE S

12" HDPE E

RIM = 949.92

12" HDPE NW

12" HDPE N

12" HDPE SW

RIM = 948.10

12" HDPE N

12" HDPE S

RIM = 949.00

8" HDPE NW

3" PE W

CB-5, 4' DIA, BEEHIVE RIM = 948.50

CB-6, 4' DIA, BEEHIVE

12" HDPE S

CB-2, 4' DIA, EJIW 7060

AT 1/4" PER FOOT ON ENTRY WALK.

5. ZONING IS R3 WITH WEST MAIN OVERLAY

PROVIDED 78 SPACES 4 ADA 74 REGULAR

945.95

945.74

945.74

944.10

946.00

LEGEND

HEAVY DUTY BITUMINOUS PAVEMENT

(SEE DETAIL SHEET)

LIGHT DUTY ASPHALT

(SEE DETAIL SHEET)

EXISTING ASPHALT PAVEMENT

CONCRETE PAVEMENT AND SIDEWALK

BIT VALLEY CURB (SEE DETAIL SHEET)

C4 SPILLOUT CURB AND GUTTER (SEE DETAIL

BENCHMARK INFORMATION

CHISLED SQUARE ON NORTH SIDE OF

OF CONCRETE GENERATOR PAD

CHISLED SQUARE ON NORTHWEST CORNER

SET 60D SPIKE IN SOUTH SIDE OF POWER

- CONTRACTOR SHALL LOCATE AND VERIEV ELEVATION OF

EXISTING SEWER LEAD PRIOR


PLUMBING WITHIN THE BLDG.


ELEV = 953.40

ELEV = 952.65


ELEV = 955.16

CONCRETE LIGHT POLE

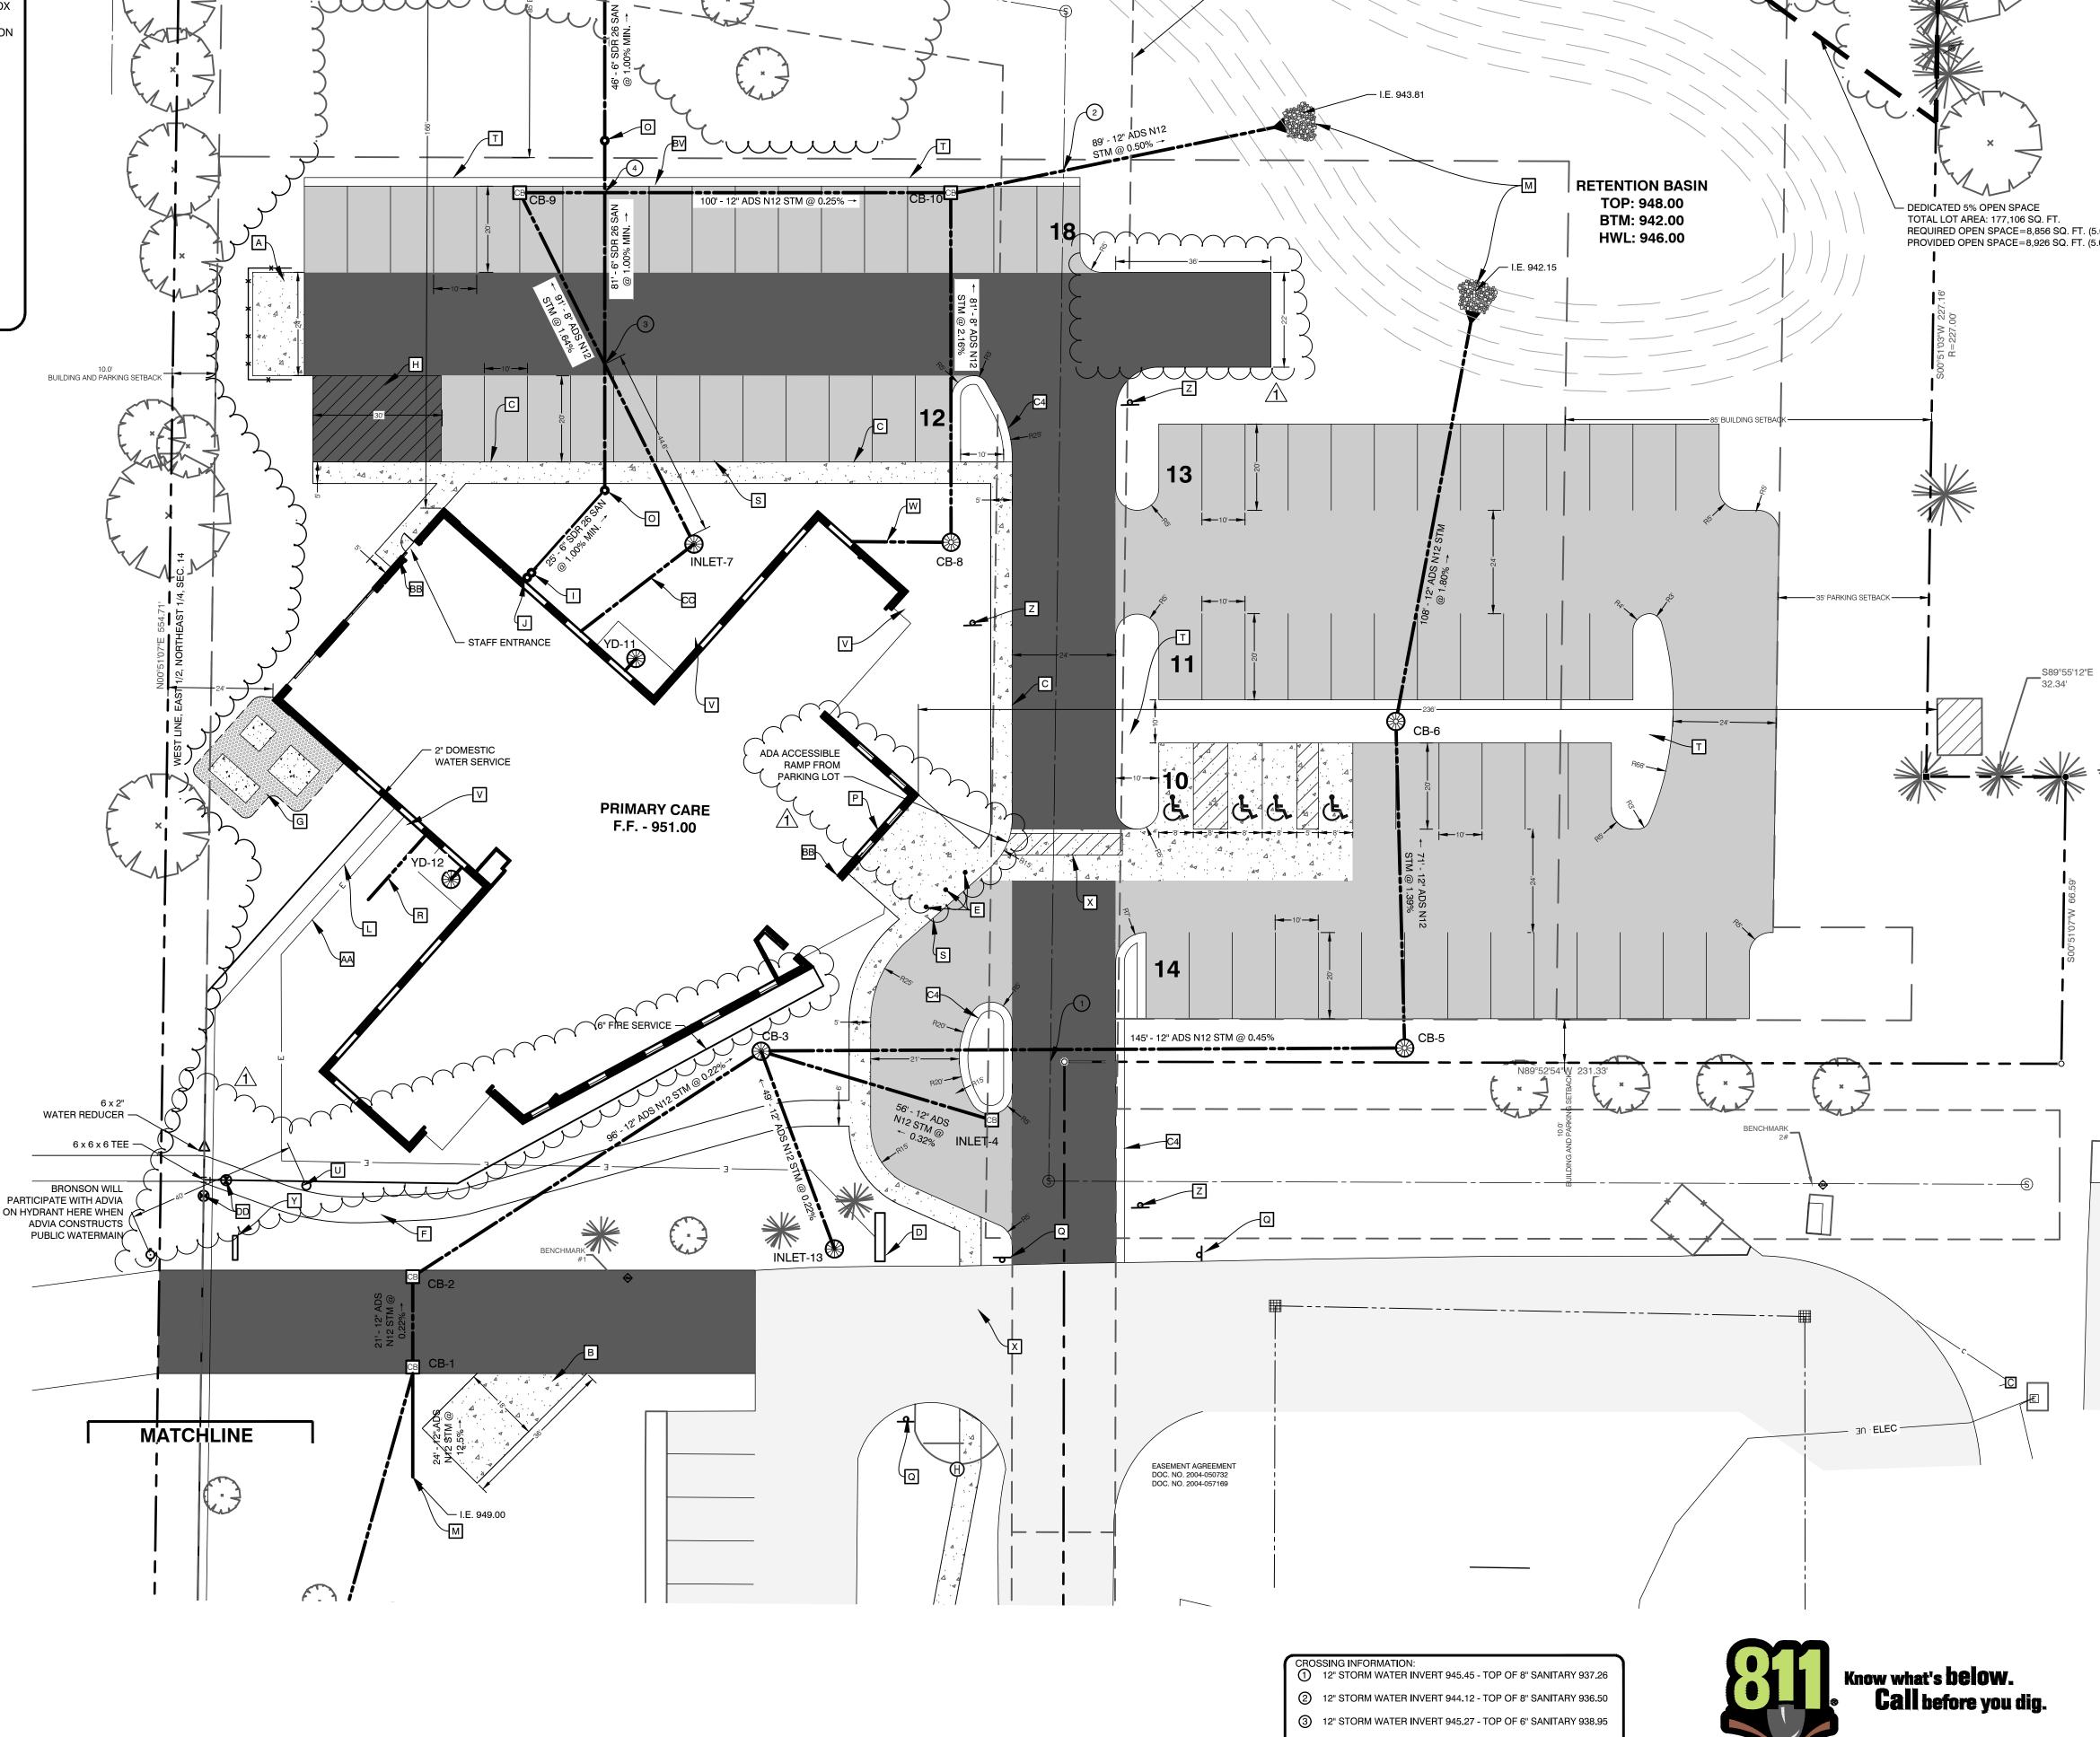

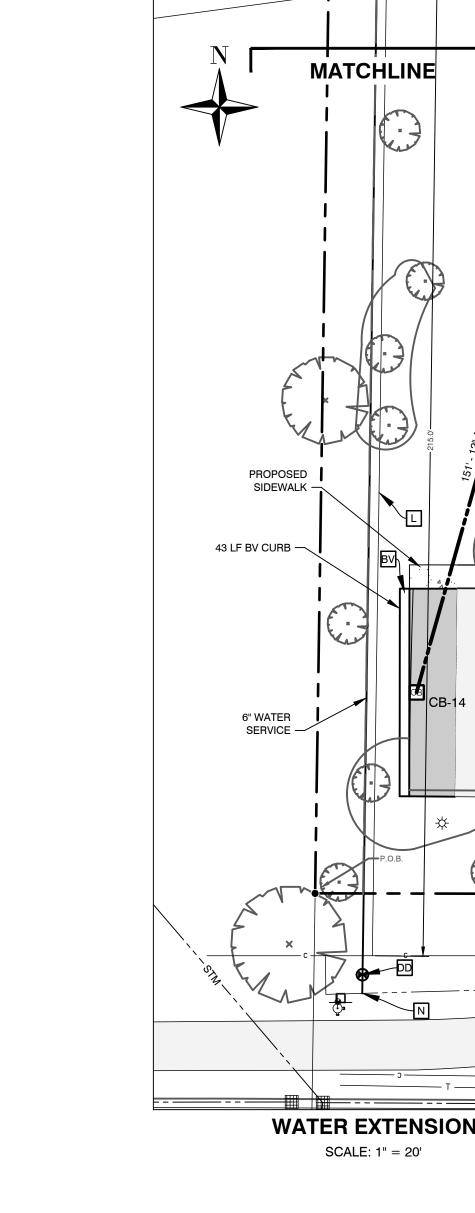

SCALE: 1" = 20'

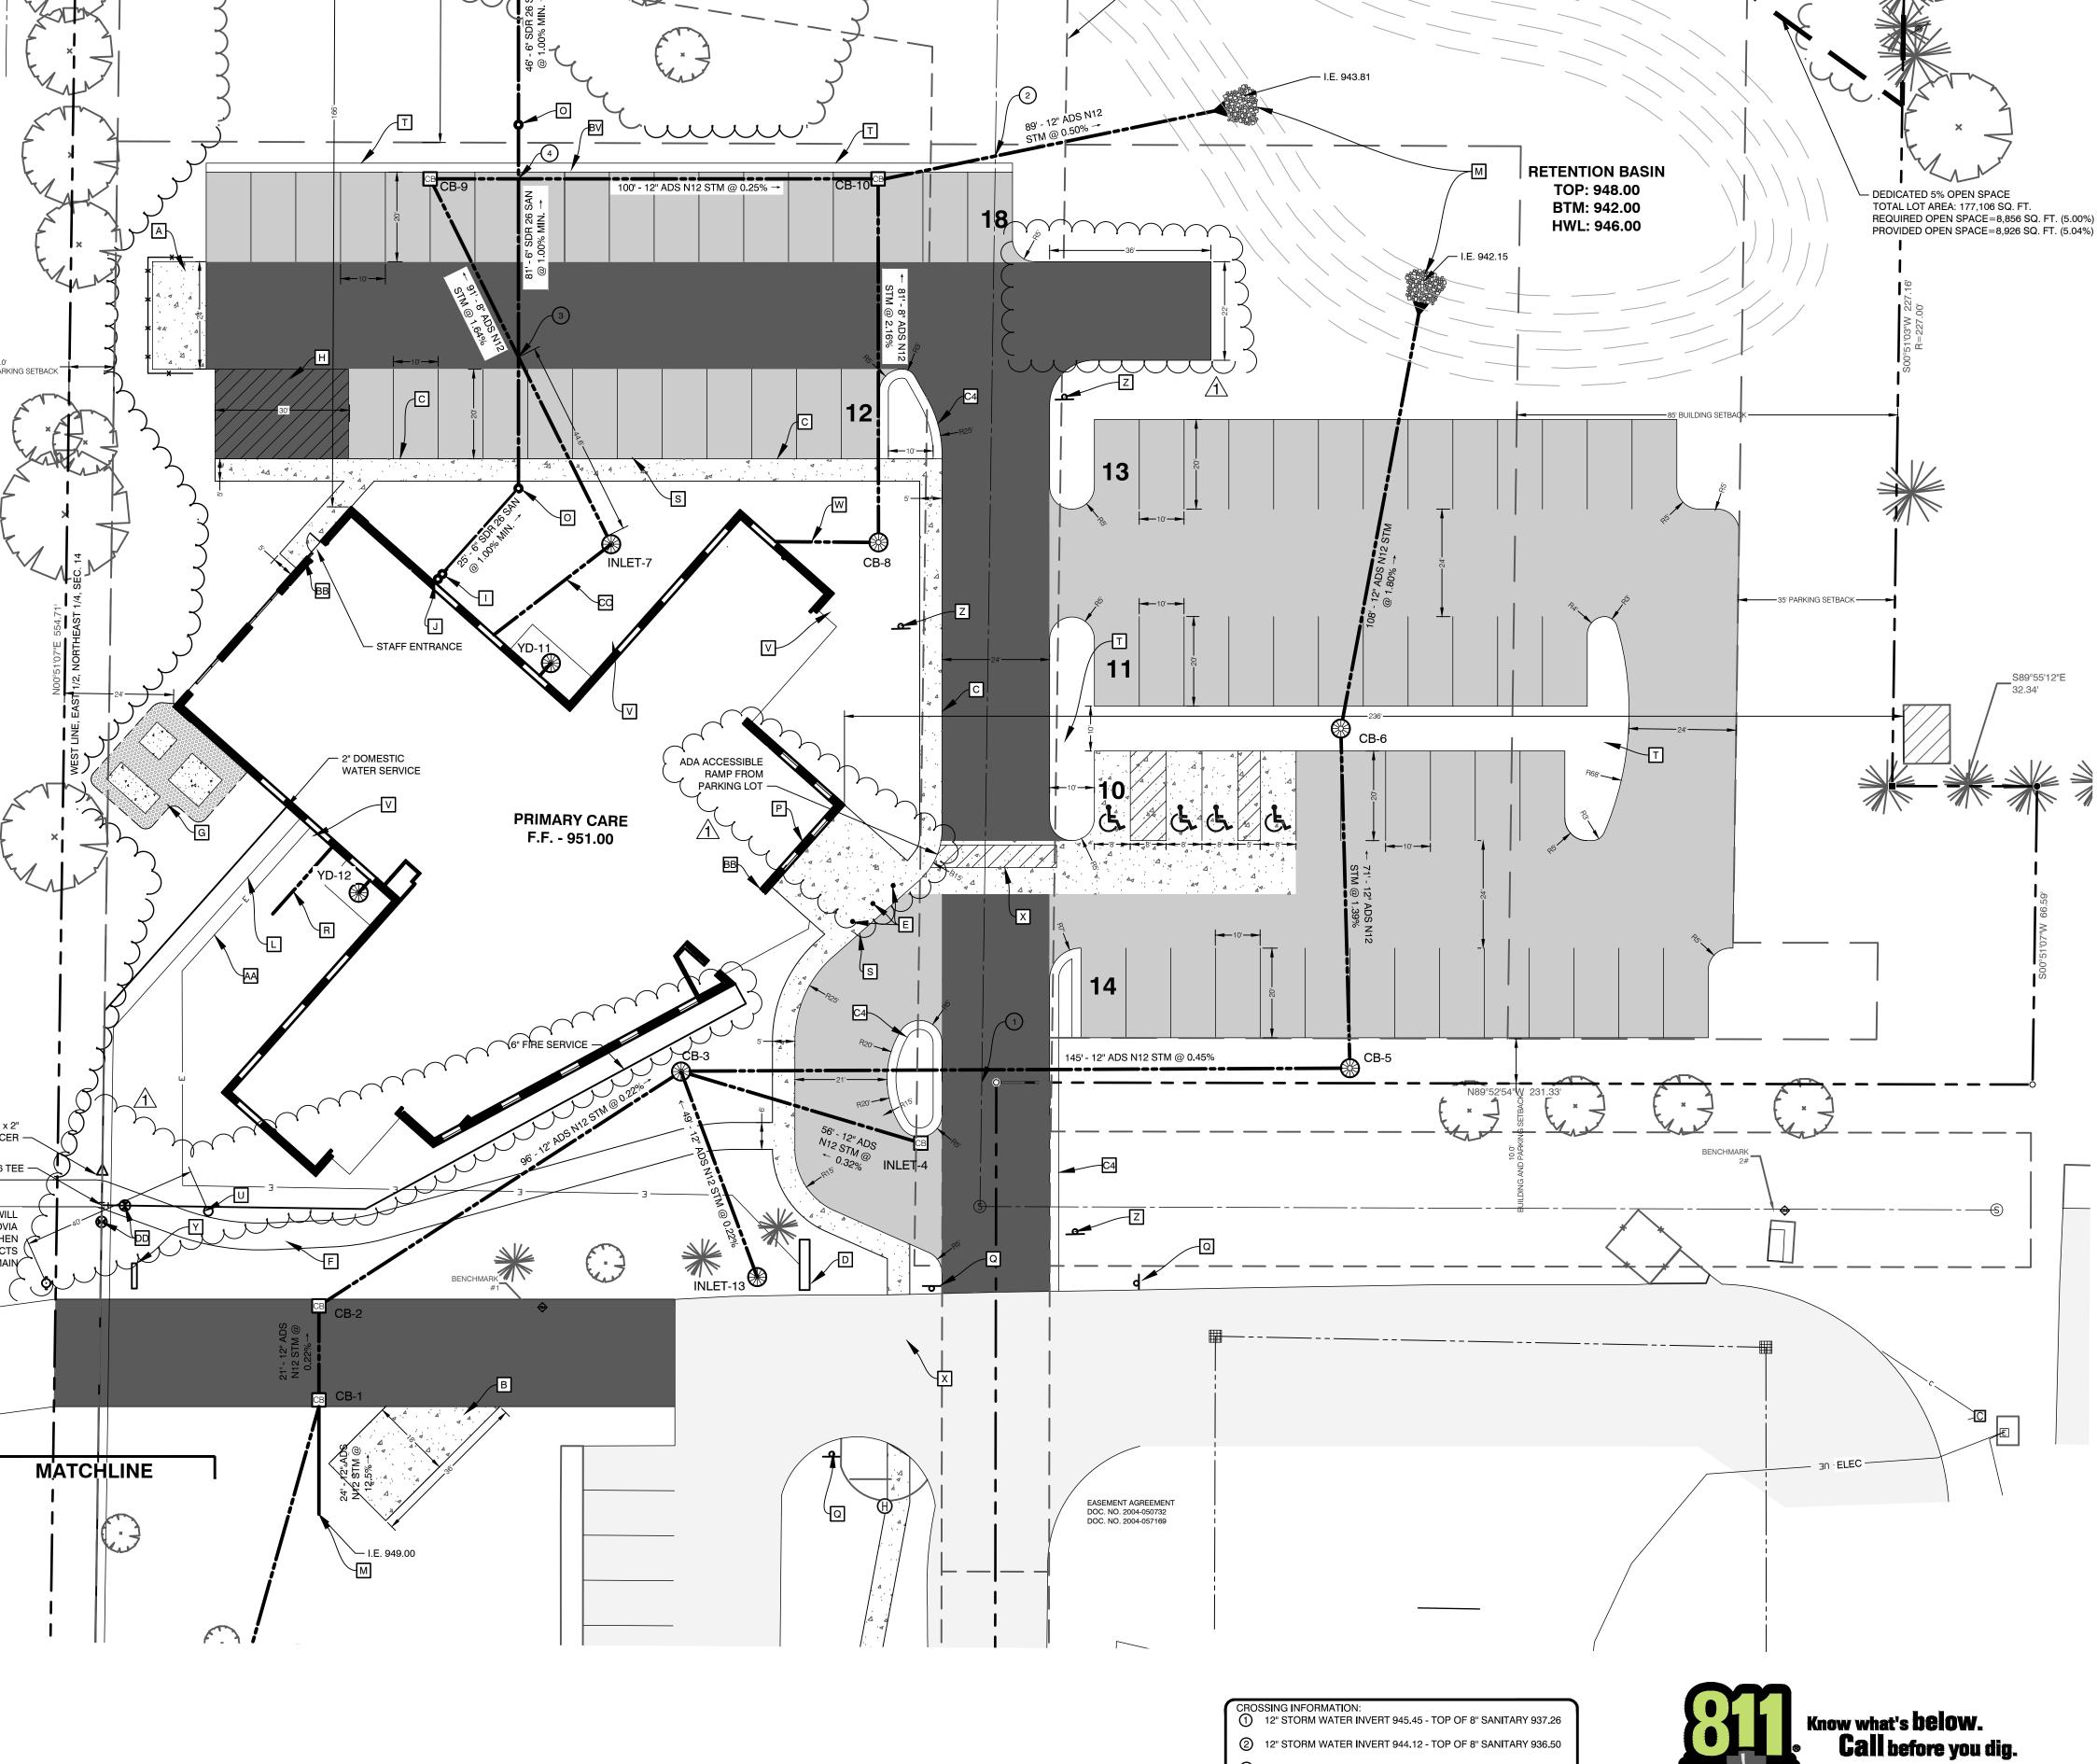

SITE MATERIALS & CONSTRUCTION NOTES:

WRAPPED WITH FILTER FABRIC

SAME DAY THE EXCAVATION IS MADE. IF THIS IS 6. PROVIDE MINIMUM 5' COVER FROM FINISHED

4. SANITARY SEWER PIPE MAY BE PVC SDR 3034

5. WATER SERVICE LINE SHALL BE DUCTILE IRON

AND SHALL BE BROUGHT TO WITHIN 5' OF

GRADE FOR ALL WATER SERVICE LINES. IF

CONDITIONS OR INVERT ELEVATIONS THE

BE PROTECTED WITH 2" RIGID INSULATION

7. PROVIDE MINIMUM 5' COVER FROM FINISHED

BOARD ON THE TOP AND SIDES.

BOARD ON THE TOP AND SIDES.

COVER CANNOT BE MAINTAINED DUE TO SITE

ENTIRE LENGTH OF THE EXTERIOR PIPE MUST

GRADE FOR ALL SANITARY SEWER LINES. IF

CONDITIONS OR INVERT ELEVATIONS THE

BE PROTECTED WITH 2" RIGID INSULATION

COVER CANNOT BE MAINTAINED DUE TO SITE

ENTIRE LENGTH OF THE EXTERIOR PIPE MUST

SANITARY SEWER

(4) 12" STORM WATER INVERT 944.46 - TOP OF 6" SANITARY 938.56

8. MAINTAIN 10 FOOT MINIMUM HORIZONTAL

9. THE CONTRACTOR SHALL INSTALL A

10. EXTERIOR CONCRETE SHALL HAVE A

AS REQUIRED.

BROOM FINISH.

PEDESTRIAN FENCE AROUND ALL

SEPARATION BETWEEN THE SEWER AND

VERTICAL SEPARATION WHERE UTILITIES

EXCAVATIONS TO BE LEFT OPEN OVERNIGHT

COMPRESSIVE STRENGTH OF 4000 PSI AND

SHALL HAVE LIMESTONE AGGREGATE AND

SHALL HAVE 4 - 6 % AIR ENTRAINMENT WITH A

. EXPANSION JOINTS IN CONCRETE PAVEMENT

IMPREGNATED FULL DEPTH 40' O.C. MAXIMUM

& AT SIDEWALK INTERSECTIONS. CRACK

CONTROL SCORING AT SIDEWALK WIDTH DIMENSION AND @ 10'-0" O.C. IN DRIVES.

AND WALLS SHALL BE 1/2" ASPHALT

WATER MAIN UTILITIES. PROVIDE 18" MINIMUM

SOILS EXPOSED IN THE BASE OF ALL

SATISFACTORY FOUNDATION EXCAVATIONS

DETRIMENTAL CHANGES IN CONDITION SUCH

AS FROM DISTURBANCE, RAIN AND FREEZING.

DRAINED AWAY FROM THE EXCAVATION AND

FOOTING CONCRETE SHOULD BE POURED THE

NOT PRACTICAL, THE FOOTING EXCAVATIONS

THAT MAY BE SOFTENED BY RAINS, FREEZING,

REPLACE WITH COMPACTED GRANULAR FILL.

STORM SEWER SHALL BE CORRUGATED HDPE

EQUAL. LEACHING BASINS AND MANHOLES

SEWER & LEACHING BASINS ARE TO BE

PIPE WITH SMOOTH INTERIOR WALL, BY ADS OR

ARE TO BE REINFORCED CONCRETE WITH RIM

AND SLOTTED GRATING (AS SHOWN). STORM

SHOULD BE ADEQUATELY PROTECTED.


REMOVE ALL SUBGRADE GRADE MATERIAL

OR CONSTRUCTION TRAFFIC, ETC. AND

NOT ALLOWED TO POND. IF POSSIBLE, ALL

SHOULD BE PROTECTED AGAINST ANY


SURFACE RUN-OFF WATER SHOULD BE

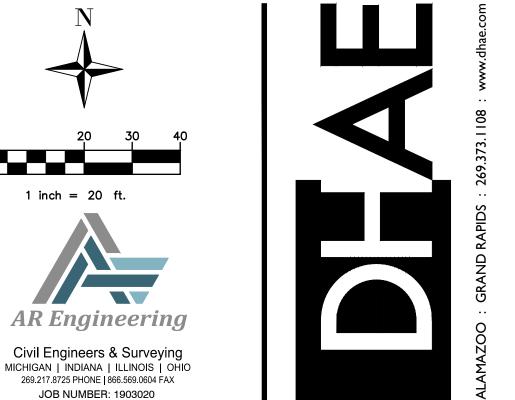


KALAMAZOO OFFICE 612 South Park Street Kalamazoo, Michigan 49007

15 Ionia SW - Suite 330 Grand Rapids, Michigan 49503

GRAND RAPIDS OFFICE

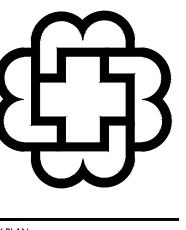

ALL PLANS, ELEVATIONS, SCHEDULES, ETC. REFERENCE PLAN NORTH. ACTUAL BUILDING ORIENTATION ON THE "TRUE NORTH" DIFFERS FROM THE DRAWING **PLAN NORTH**. REFER TO COVER SHEET AND SITE PLAN FOR TRUE ORIENTATION OF THE BUILDING ON THE SITE.

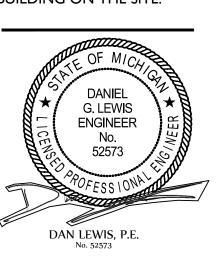

SITE PLAN SUBMITTAL ISSUED FOR BIDS OSHTEMO COMMENTS ADDENDUM #01 POST-BID ADDENDUM #01 06/05/2019

JUNE 06, 2019

19015.01

SITE / UTILITY PLAN

C3.0

CONST. DOCUMENTS This drawing, as an instrument of service, is owned by the diekema hamann architecture, inc.

Reproduction of this document is prohibited without express authorization from the architect. © 2019 DIEKEMA|HAMANN ARCHITECTURE

ALL UTILITIES AS SHOWN ARE APPROXIMATE LOCATIONS DERIVED

FROM ACTUAL MEASUREMENTS AND AVAILABLE RECORDS. THEY

SHOULD IT BE ASSUMED THAT THEY ARE THE ONLY UTILITIES IN THE


SHOULD NOT BE INTERPRETED TO BE EXACT LOCATION NOR


AREA. FIELD WORK PERFORMED BY: PREIN & NEWHOF


SOIL EROSION & SEDIMENTATION CONTROL NOTES ALL CONSTRUCTION METHODS SHALL BE DONE IN COMPLIANCE WITH MDOT-MDEQ. THE OWNER SHALL BE RESPONSIBLE FOR OBTAINING A "SOIL EROSION PERMIT" FROM THE COUNTY AND A "PERMIT BY RULE/NOTICE OF COVERAGE" FROM MDEQ, IF APPLICABLE, PRIOR TO START OF CONSTRUCTION. THE CONTRACTOR SHALL BE RESPONSIBLE FOR COMPLYING WITH ALL REQUIREMENTS OF THE COUNTY "SOIL EROSION PERMIT" AND FOR ALL CERTIFIED STORM WATER INSPECTION SERVICE REQUIRED BY THE "PERMIT BY RULE." EROSION CONTROL MEASURES SHOWN ON THE PLANS ARE THE MINIMUM REQUIREMENTS AND SHALL NOT RELIEVE THE CONTRACTOR'S RESPONSIBILITY FOR PROVIDING ALL REQUIRED EROSION CONTROL MEASURES. AVOID UNNECESSARY DISTURBING OR REMOVING OF EXISTING VEGETATED TOPSOIL OR EARTH COVER, THESE COVER ALL TEMPORARY SOIL EROSION PROTECTION SHALL REMAIN IN PLACE UNTIL REMOVAL IS REQUIRED FOR FINAL CLEAN GEOTEXTILE SILT FENCE SHALL BE INSTALLED AS REQUIRED WHEN CROSSING CREEKS OR WHEN ADJACENT TO WETLANDS OR SURFACE WATER BODIES TO PREVENT SILTATION AND ELSEWHERE AS DIRECTED BY THE ENGINEER. SEEDING AND/OR SODDING SHALL BE INSTALLED ON CREEK BANKS IMMEDIATELY AFTER CONSTRUCTION TO PREVENT MAINTENANCE, CLEANING, AND REMOVAL OF THE VARIOUS SEDIMENT CONTROL MEASURES SHALL BE INCLUDED IN THE VARIOUS EROSION CONTROL ITEMS. NUMBER IN CIRCLE REFERS TO NUMBERED DETAILS ON MDOT STANDARD PLAN R-96-D, SOIL EROSION & SEDIMENTATION CONTROL MEASURES. "P" DENOTES PERMANENT MEASURE AND "T" DENOTES TEMPORARY MEASURE. SOIL EROSION CONTROL PLANS DENOTE MINIMUM EROSION MEASURES REQUIRED AS DESCRIBED BELOW. DENOTES PERMANENT SEEDING. ALL DISTURBED AREAS NOT PAVED OR GRAVELED SHALL BE RESTORED. PLACE TOPSOIL SURFACE, SALV, 3 INCH, MDOT SEEDING, MIXTURE TUF APPLIED AT A RATE OF 220 LB/ACRE, FERTILIZER, CHEMICAL NUTRIENT, CL A APPLIED AT A RATE OF 228 LB/ACRE; MULCH AT A RATE OF 2 TON/ACRE AND MULCH ANCHORING. (APPLIES TO ENTIRE PROJECT) DENOTES DUST CONTROL. DUST CONTROL MAY BE REQUIRED ON THE SUBGRADE CONSTRUCTION AND WILL INCLUDE APPLYING FRESH WATER TO BE INCLUDED IN THE ITEM OF EMBANKMENT. DUST CONTROL ON THE AGGREGATE BASE COURSE WILL BE ACCOMPLISHED BY APPLYING FRESH WATER (INCLUDED IN THE ITEM OF AGGREGATE BASE, 6 INCH) AND APPLYING DUST PALLIATIVE, APPLIED, CaCl₂ (TON) AS DIRECTED BY THE PROJECT ENGINEER. (8P) DENOTES AGGREGATE COVER/PERMANENT PAVEMENT RESTORATION DENOTES GRAVEL ACCESS APPROACH. APPROACH SHALL BE INSTALLED TO PROVIDE STABLE ACCESS TO ROADWAYS AND MINIMIZE DUST AND TRACKING OF MATERIALS ONTO PUBLIC STREETS AND HIGHWAYS. THE APPROACH SHALL BE A MINIMUM OF 12' WIDE, 6" DEEP, AND CONSIST OF 2"-4" AGGREGATE DENOTES INLET PROTECTION FABRIC DROP. SHALL BE INSTALLED AT EXISTING AND PROPOSED STORM SEWER INLETS TO PROVIDE SETTLING AND FILTERING OF SILT LADEN WATER PRIOR TO ENTRY INTO THE DRAINAGE SYSTEM. GRADING NOTES

- ALL WORK SHALL CONFORM TO ALL LOCAL, STATE AND FEDERAL LAWS, RULES AND REGULATIONS IN FORCE AT TIME OF CONSTRUCTION.
- THE GENERAL CONTRACTOR SHALL BE RESPONSIBLE FOR OBTAINING ALL PERMITS, PERMIT COSTS, TAP FEES, METER DEPOSITS, PERMANENT UTILITY APPLICATIONS, BONDS, AND OTHER FEES REQUIRED FOR PROPOSED WORK. THIS SHALL INCLUDE, BUT SHALL NOT BE LIMITED TO THOSE REQUIRED BY THE CITY OF KALAMAZOO.
- CONTACT "811" AT 1-800-482-7171 FOR LOCATION OF UNDERGROUND UTILITIES A MINIMUM OF 48 HOURS BEFORE COMMENCING EXCAVATION WORK. THIS DOES NOT RELIEVE THE CONTRACTOR OF THE RESPONSIBILITY OF NOTIFYING UTILITY OWNERS WHO ARE NOT PART OF THE "811" ALERT SYSTEM. THE CONTRACTOR SHALL CONDUCT HIS OPERATIONS IN A MANNER AS TO ENSURE THAT THOSE UTILITIES NOT REQUIRING RELOCATION WILL NOT BE DISTURBED.
- 4. DEMOLISH & REMOVE ALL EXISTING SITE FEATURES AS REQUIRED.
- 5. MATCH EXISTING GRADES AROUND PERIMETER WITH SLOPES AS SHOWN.
- . ALL SPOT ELEVATIONS ARE TOP OF PAVEMENT GRADES AT EDGE OF METAL (EOM) UNLESS
- ALL SOIL EROSION CONTROL MEASURES SHALL BE IN PLACE PRIOR TO MASS GRADING.
- . ALL EXCAVATION SHALL BE IN ACCORDANCE WITH THE TECHNICAL SPECIFICATIONS AND GEOTECHNICAL REPORT.
- ALL EXISTING ELEVATIONS ARE TO BE VERIFIED AND ACCEPTED AS SHOWN PRIOR TO COMMENCEMENT OF WORK.
- 10. CONTRACTOR SHALL TAKE PRECAUTIONS TO AVOID TRACKING SOIL ONTO ADJACENT ROADWAYS. CONTRACTOR SHALL SWEEP IMMEDIATELY IF OCCURS.
- ANY DISTURBED AREA WHICH WILL BE LEFT UNWORKED 15 DAYS OR LONGER MUST BE SEEDED TO ESTABLISH VEGETATION FOR TEMPORARY STABILIZATION. BASINS TO BE SEEDED AND MULCH

BLANKETS APPLIED IMMEDIATELY TO PROVIDE A STABLE BASE AND AVOID EXCESSIVE EROSION.

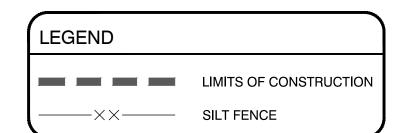


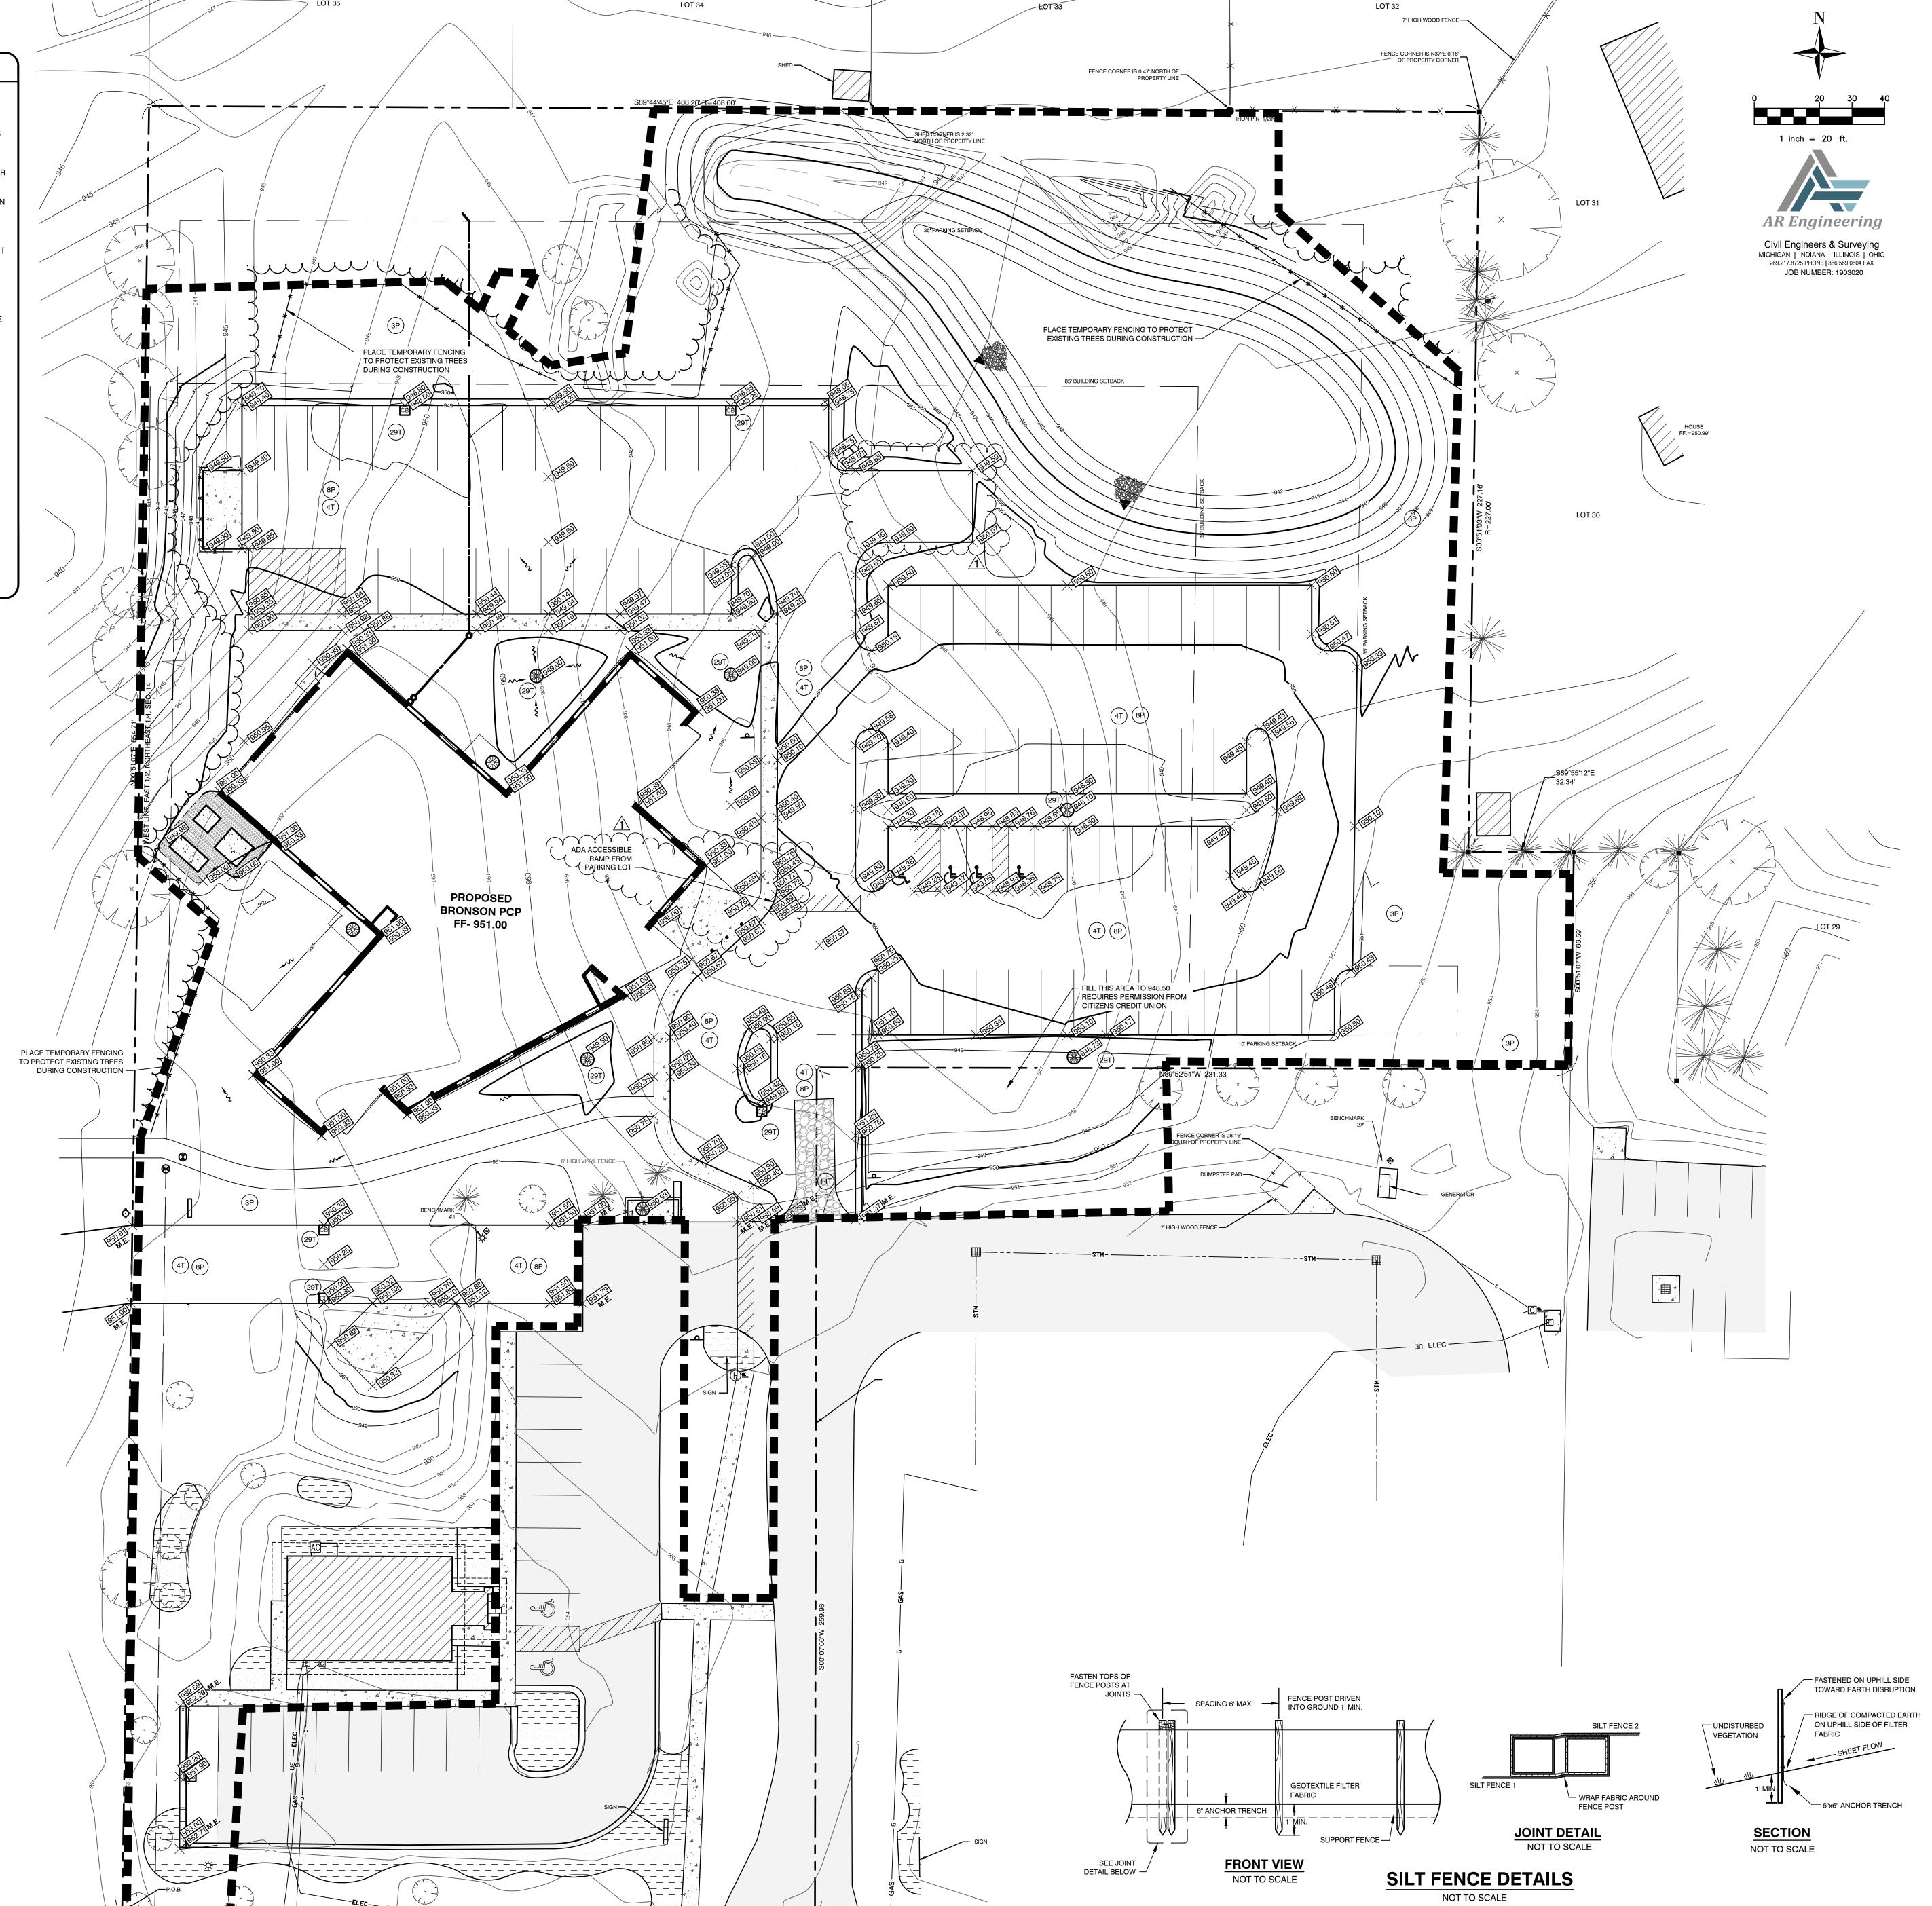

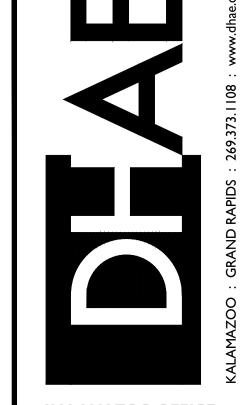


KALAMAZOO OFFICE 612 South Park Street Kalamazoo, Michigan 49007

GRAND RAPIDS OFFICE 15 Ionia SW - Suite 330 Grand Rapids, Michigan 49503

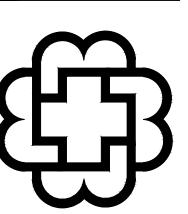

ALL PLANS, ELEVATIONS, SCHEDULES, ETC. REFERENCE PLAN NORTH. ACTUAL BUILDING ORIENTATION ON THE "TRUE NORTH" DIFFERS FROM THE DRAWING **PLAN NORTH**. REFER TO COVER SHEET AND SITE PLAN FOR TRUE ORIENTATION OF THE BUILDING ON THE SITE.

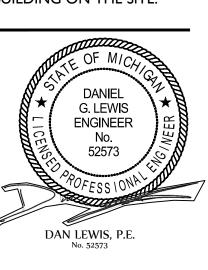

SITE PLAN SUBMITTAL ISSUED FOR BIDS OSHTEMO COMMENTS ADDENDUM #01 POST-BID ADDENDUM #01 06/05/2019

JUNE 06, 2019

19015.01


GRADING & SESC PLAN


C4.0

CONST. DOCUMENTS This drawing, as an instrument of service, is owned by the diekema hamann architecture, inc.
Reproduction of this document is prohibited without express authorization from the architect.

© 2019 DIEKEMA|HAMANN ARCHITECTURE

ALL UTILITIES AS SHOWN ARE APPROXIMATE LOCATIONS DERIVED FROM ACTUAL MEASUREMENTS AND AVAILABLE RECORDS. THEY SHOULD NOT BE INTERPRETED TO BE EXACT LOCATION NOR SHOULD IT BE ASSUMED THAT THEY ARE THE ONLY UTILITIES IN THE AREA. FIELD WORK PERFORMED BY: PREIN & NEWHOF

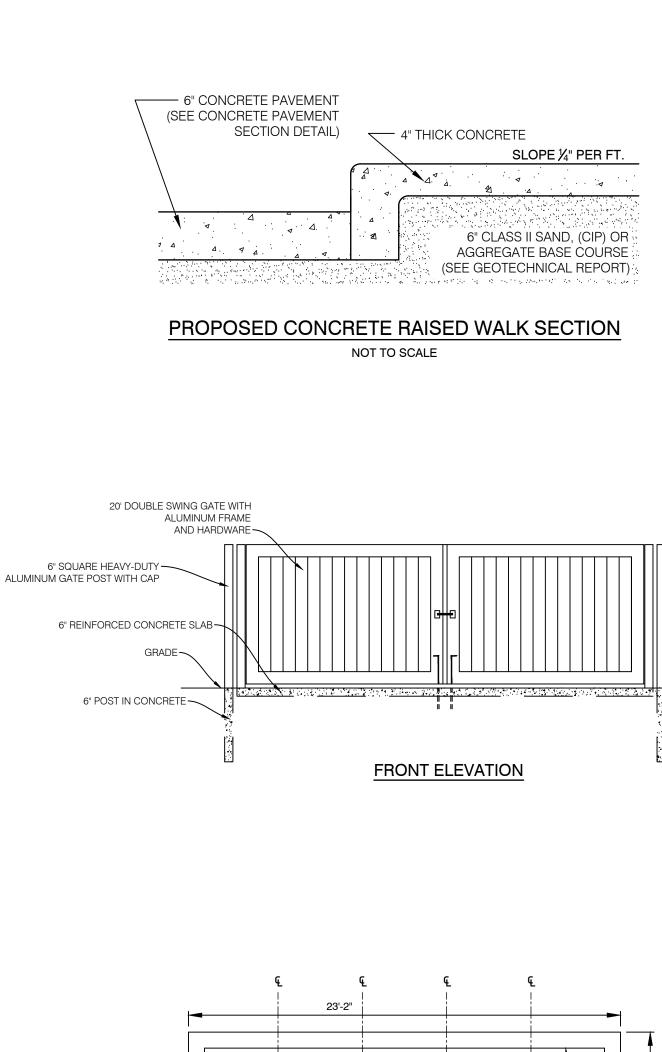

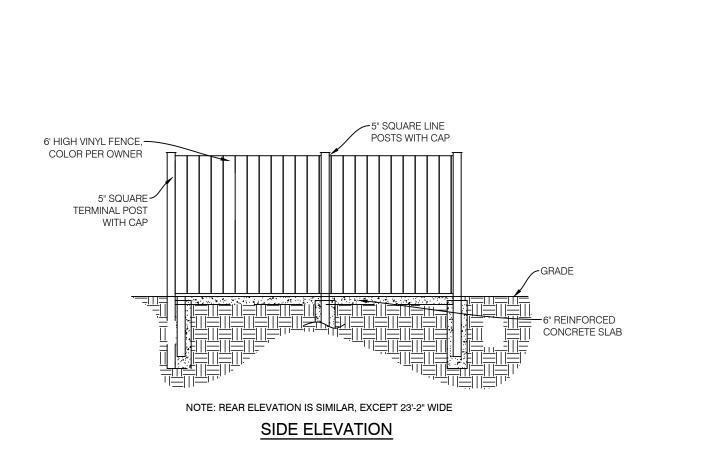

TOPSOIL -

8" COMPACTED AGGREGATE BASE (MDOT 21AA)

2" ASPHALT WEARING COURSE (MDOT 36A)

2" ASPHALT BASE COURSE (MDOT 13A)

PROPOSED ASPHALT

VALLEY GUTTER SECTION

NOT TO SCALE

. COMPACTED (95%) SAND SUB-BASE

.. (18" MIN WHERE NEEDED) MDOT

CLASS II GRANUALR MATERIAL

—— 6" MINIMUM COMPACTED (98%) SAND SUB-BASE (MDOT CLASS II)

OR AS RECOMMENDED BY

GEOTECHNICAL ENGINEER

NON-REINFORED CONCRETE

ACCEPTABLE COMPACTED

SUB-BASE (AS RECOMMENDED)


PROPOSED

CONCRETE PAVEMENT SECTION

NOT TO SCALE

BY GEOTECHNICAL ENGINEER)

6"-4,000 PSI

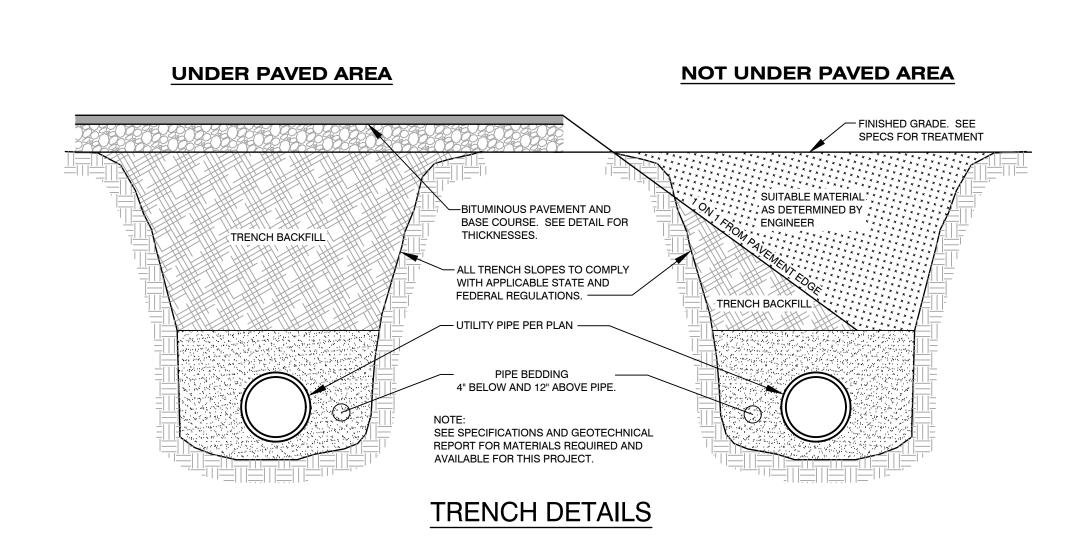

6" COMPACTED AGGREGATE BASE (MDOT 21AA)

1.5" ASPHALT WEARING COURSE (MDOT 36A)

—— 1.5" ASPHALT BASE COURSE (MDOT 13A)

COMPACTED (95%) SAND SUB-BASE

:: (18" MIN WHERE NEEDED) MDOT

CLASS II GRANUALR MATERIAL

PROPOSED LIGHT-DUTY

ASPHALT PAVEMENT SECTION

NOT TO SCALE

8" COMPACTED AGGREGATE BASE (MDOT 21AA)

2" ASPHALT WEARING COURSE (MDOT 36A)

—— 2" ASPHALT BASE COURSE (MDOT 13A)

COMPACTED (95%) SAND SUB-BASE


: (18" MIN WHERE NEEDED) MDOT

CLASS II GRANUALR MATERIAL

PROPOSED HEAVY-DUTY

ASPHALT PAVEMENT SECTION

NOT TO SCALE

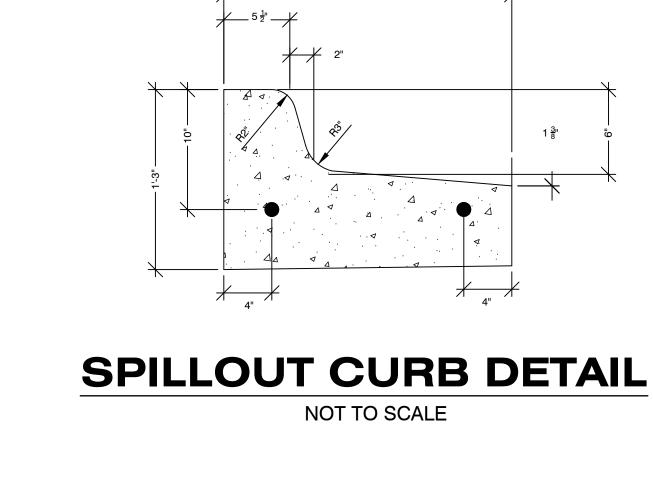

4" TOPSOIL (MDOT ROADSIDE 4" CONCRETE SIDEWALK (GRADE P1 MIX

SEED AND MULCH)

REFER TO MDOT STANDARD PLAN R-29-H

CONCRETE SIDEWALK)

(DRIVEWAY OPENINGS & APPROCHES, AND

DESIGN 6.0 SACK CONCRETE MIX)

— ¼" R (TYP.)

— 4" MIN. COMPACTED TO 95% DENSITY

(MDOT CLASS II SAND SUB-BASE)

**6" IF CROSSING DRIVE

**6" IF CROSSING DRIVE


*TRANSVERSE SIDEWALKS SLOPES ARE 2% MAXIMUM. IF THE TRANSVERSE


PROPOSED SIDEWALK SECTION


NOT TO SCALE

SLOPE IS REQUIRED TO BE LESS THAN 1.5%, IN ORDER TO MEET SITE


CONDITIONS, LONGITUDINAL DRAINAGE MUST BE PROVIDED.

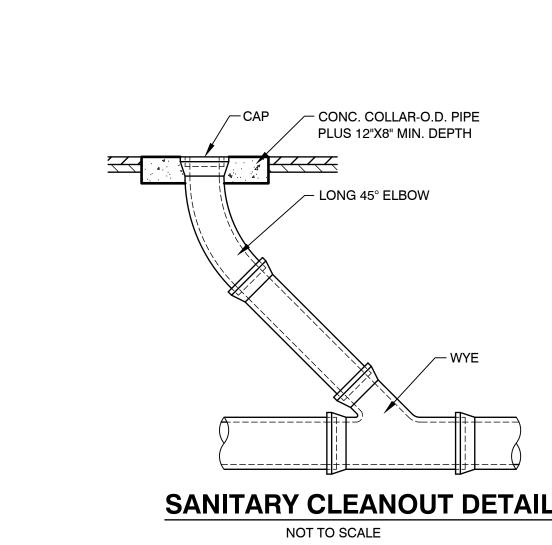


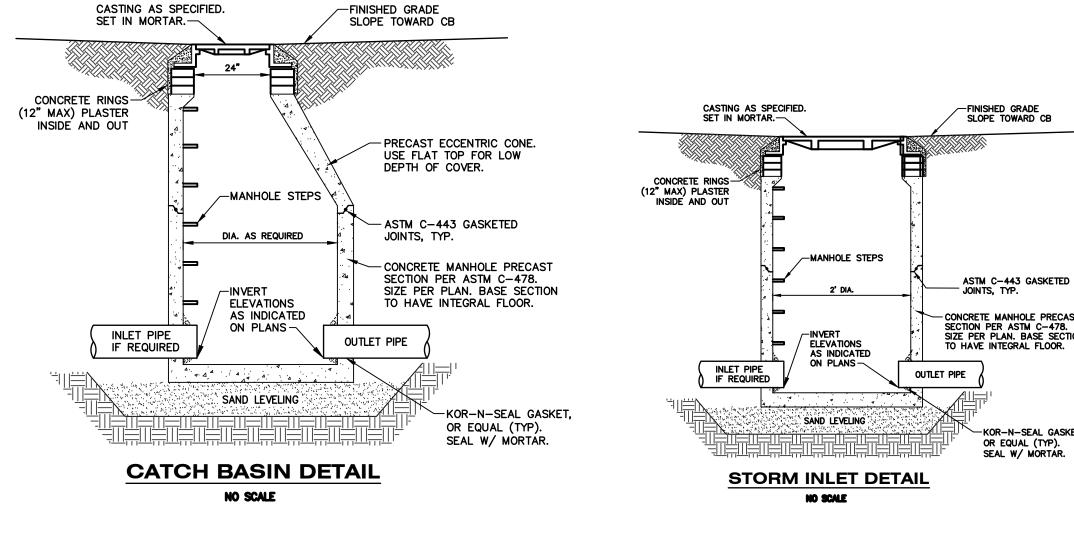

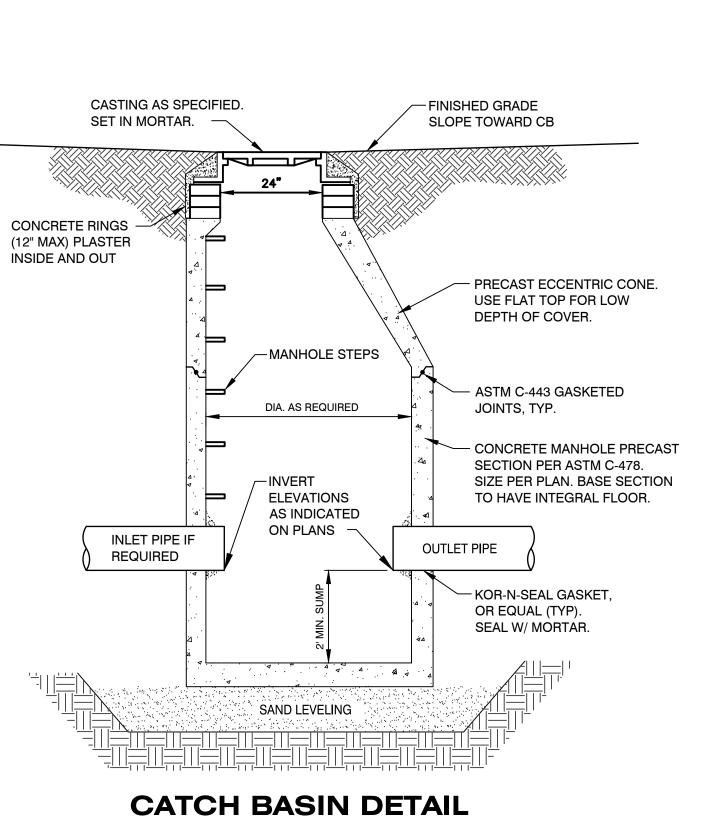


NO SCALE

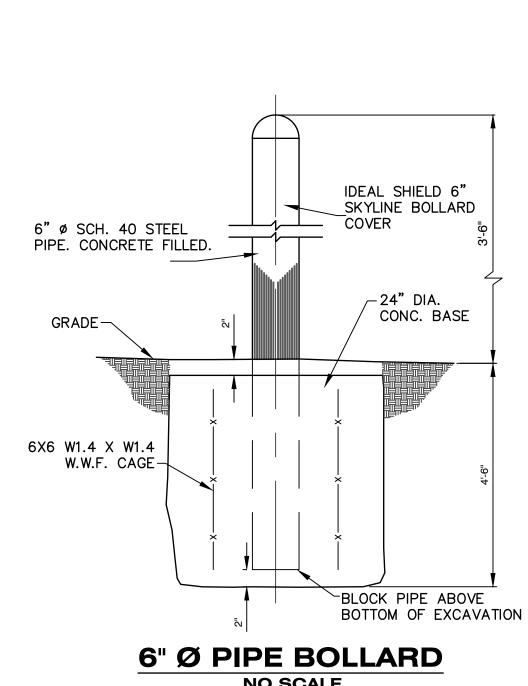

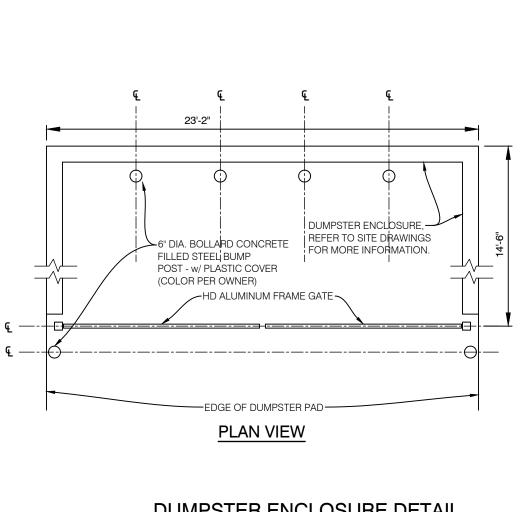

DUMPSTER ENCLOSURE DETAIL NOT TO SCALE

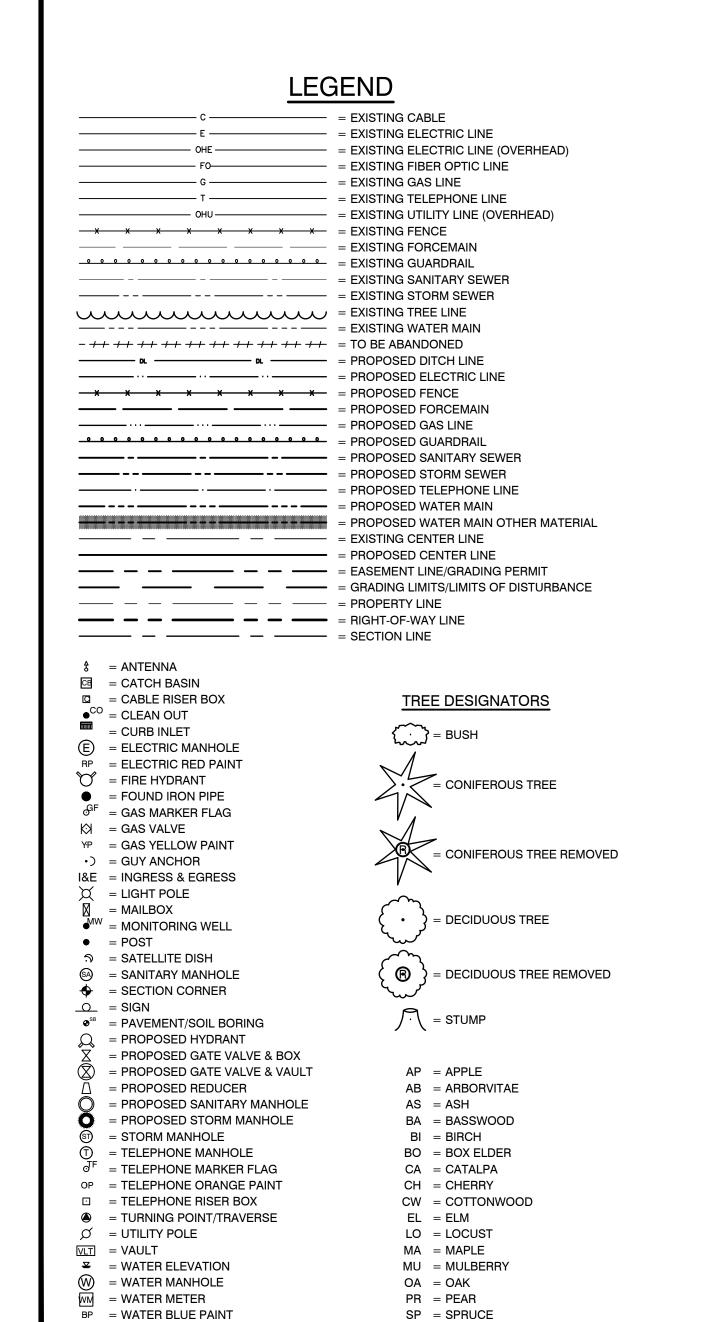

TW = TWIN


WA = WALNUT


WL = WILLOW

⋈ = WATER VALVE


⇒ = WATER SPIGOT

 $o^{W} = WELL$

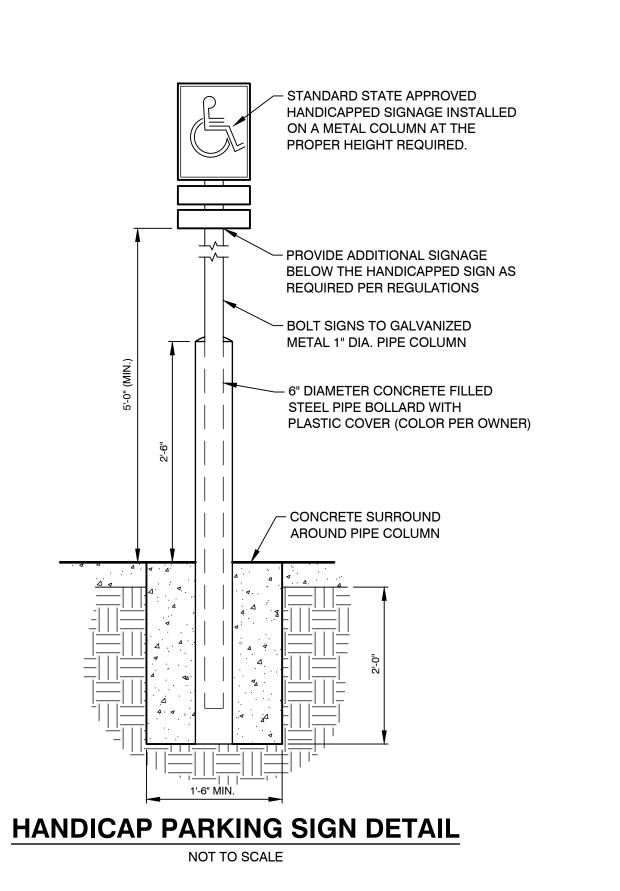

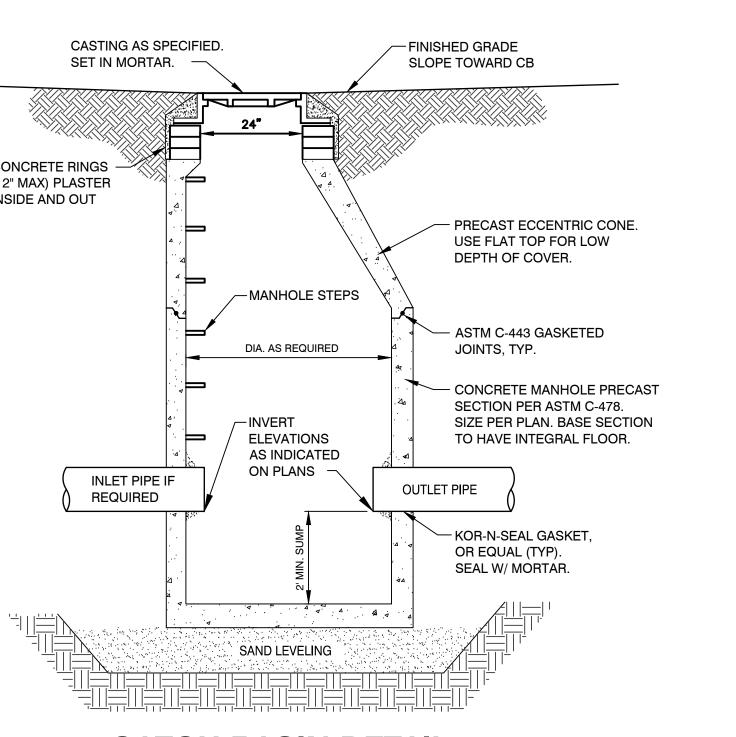



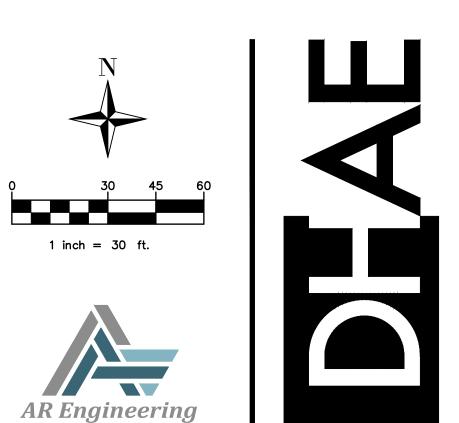


Civil Engineers & Surveying MICHIGAN | INDIANA | ILLINOIS | OHIO 269.217.8725 PHONE | 866.569.0604 FAX


JOB NUMBER: 1903020

KALAMAZOO OFFICE 612 South Park Street Kalamazoo, Michigan 49007

GRAND RAPIDS OFFICE 15 Ionia SW - Suite 330 Grand Rapids, Michigan 49503

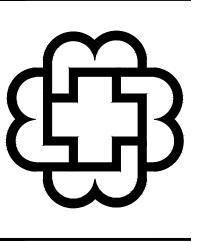

ALL PLANS, ELEVATIONS, SCHEDULES, ETC. REFERENCE **PLAN NORTH**. ACTUAL BUILDING ORIENTATION ON THE "TRUE NORTH" DIFFERS FROM THE DRAWING **PLAN NORTH**. REFER TO COVER SHEET AND SITE PLAN FOR TRUE ORIENTATION OF THE BUILDING ON THE SITE.

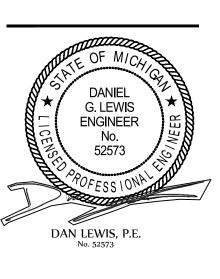

REVISIONS SITE PLAN SUBMITTAL OSHTEMO COMMENTS MAY 23, 2019


19015.01 SHEET TITLE **DETAILS**

PROJECT NUMBER

C5.0 CONST. DOCUMENTS This drawing, as an instrument of service, is owned by the diekema hamann architecture, inc.
Reproduction of this document is prohibited without

express authorization from the architect.

© 2019 DIEKEMA|HAMANN ARCHITECTURE

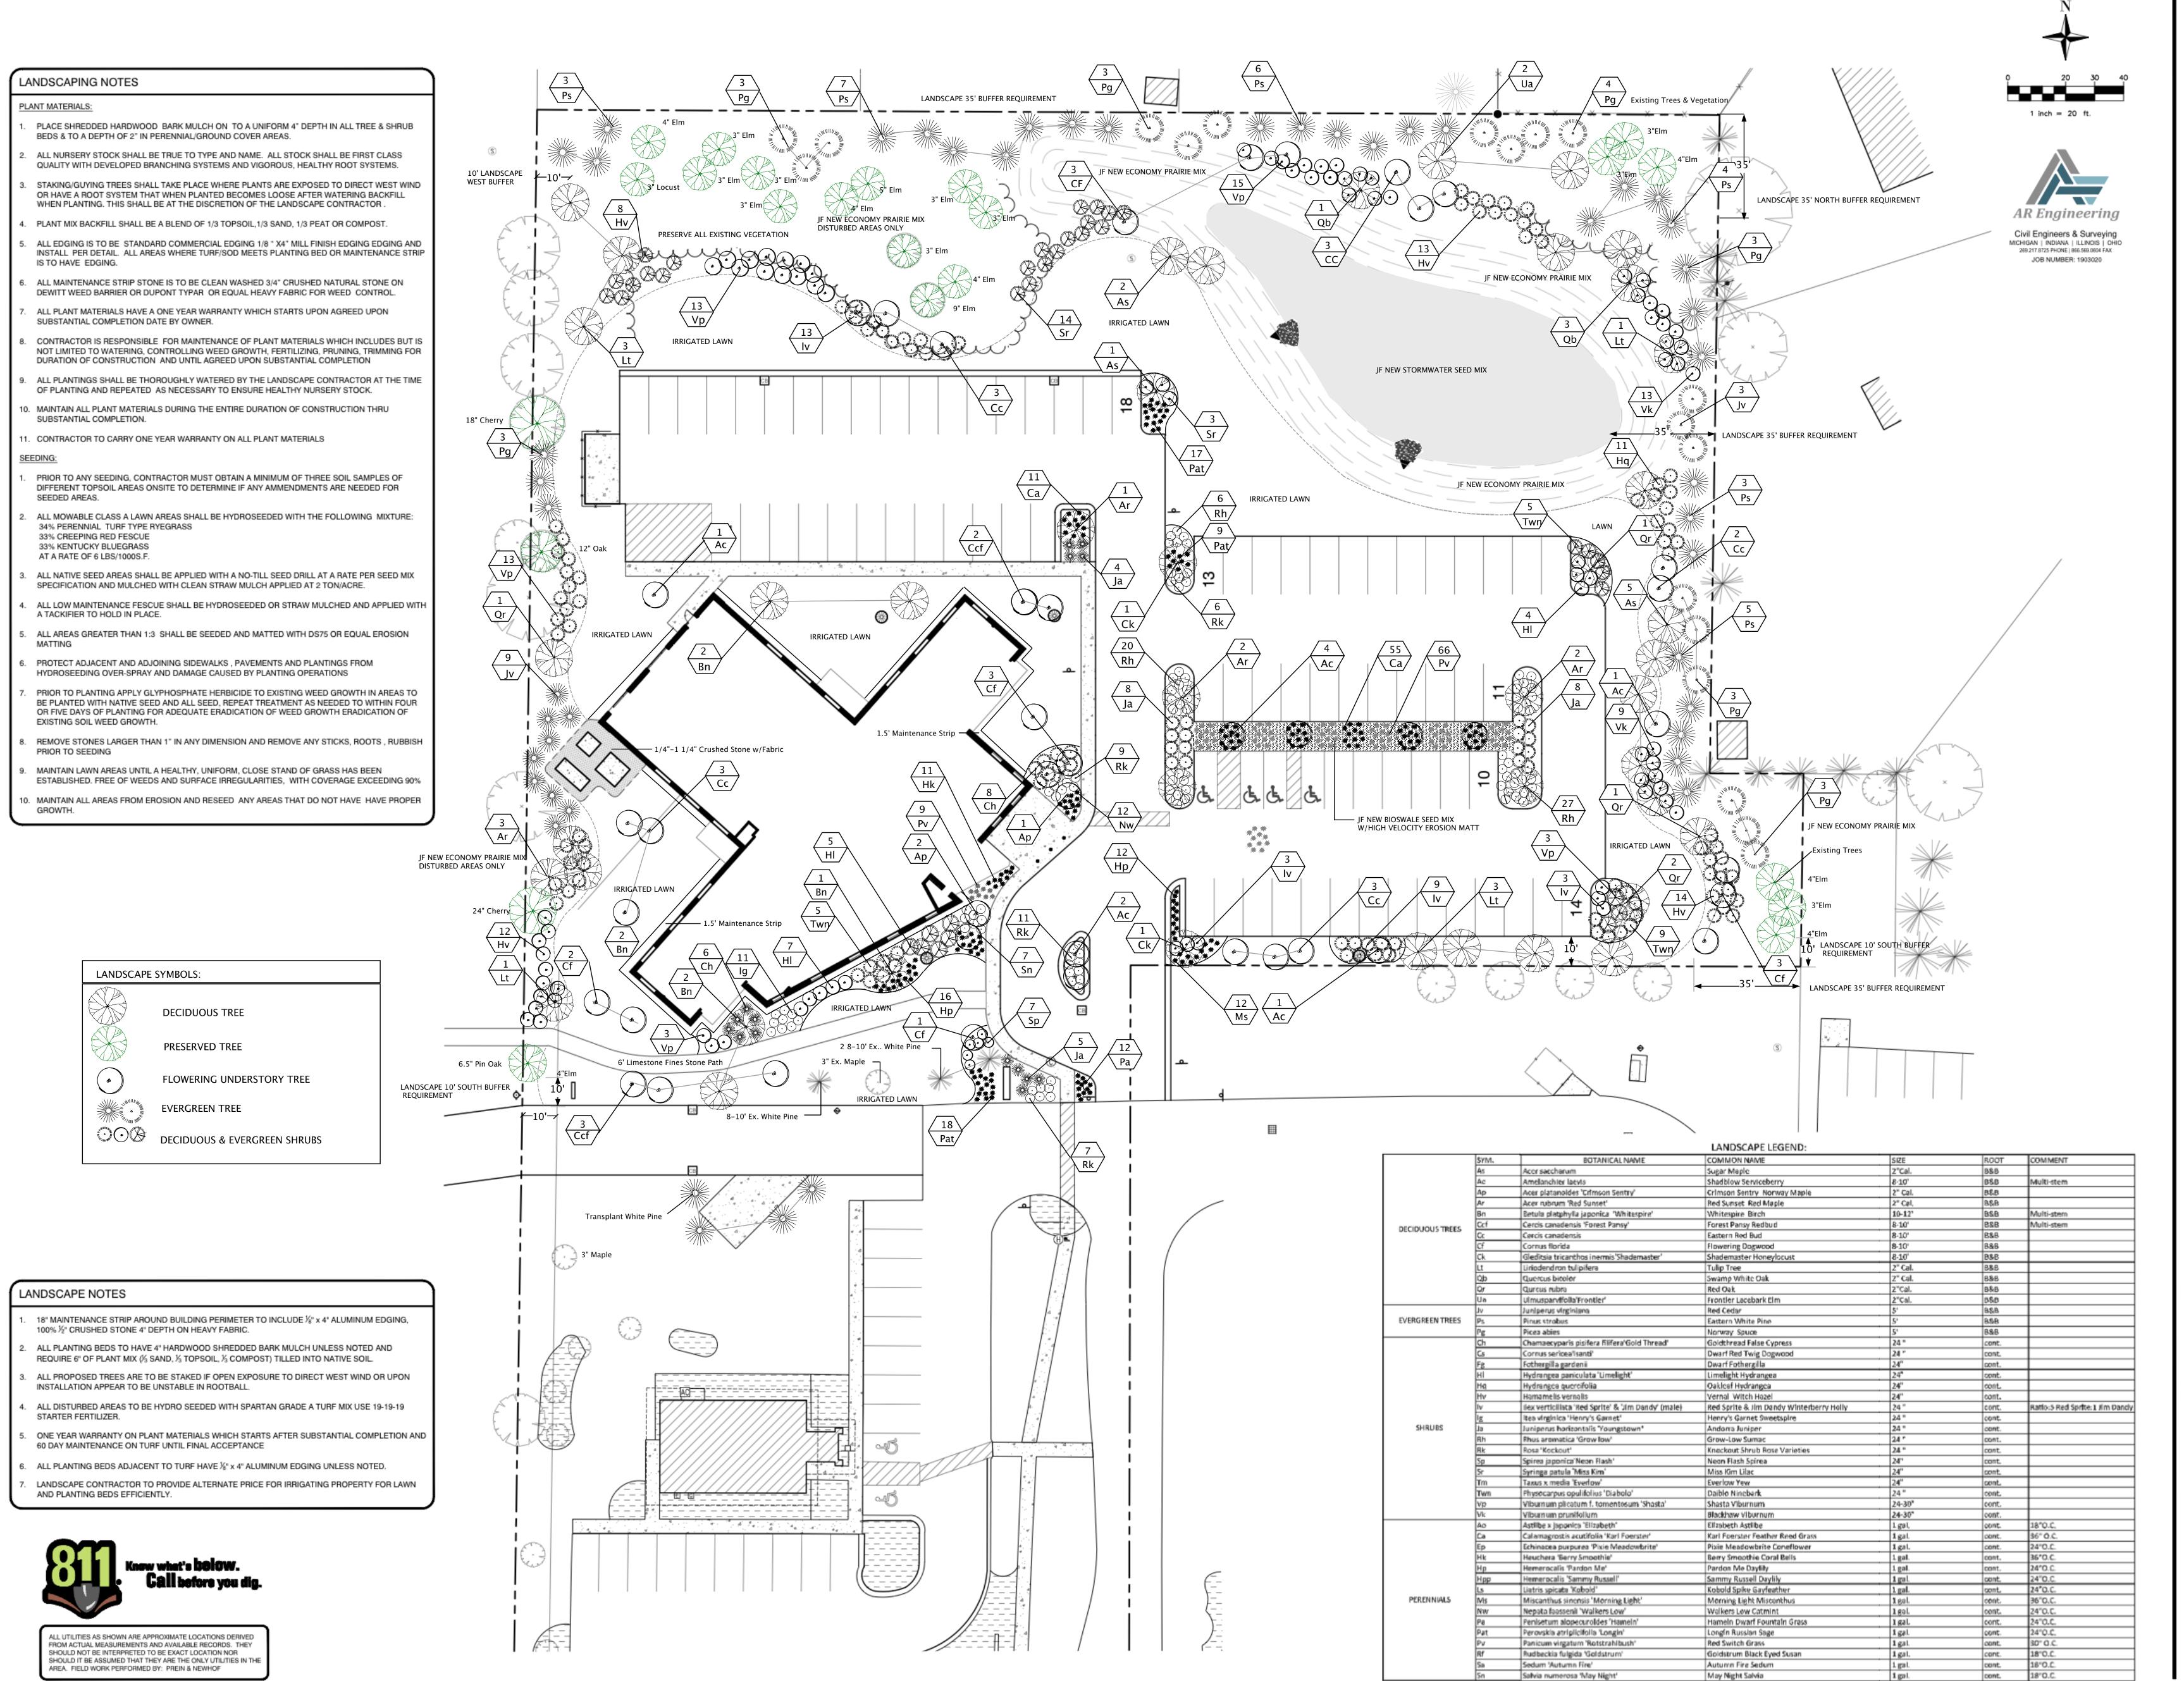

KALAMAZOO OFFICE

612 South Park Street Kalamazoo, Michigan 49007

GRAND RAPIDS OFFICE 15 Ionia SW - Suite 330 Grand Rapids, Michigan 49503

(E)

KEY PLAN PLAN NORTH

ALL PLANS, ELEVATIONS,
SCHEDULES, ETC. REFERENCE
PLAN NORTH. ACTUAL
BUILDING ORIENTATION ON
THE "TRUE NORTH"
DIFFERS FROM THE
DRAWING PLAN NORTH.
REFER TO COVER SHEET AND
SITE PLAN FOR TRUE
ORIENTATION OF THE
BUILDING ON THE SITE.

W. MAIN ST. - NEW PRIMARY CARE BUILDING

BRONSON HEALTHCARE GROUP

OSHTEMO TOWNSHIP, MICHIGAN 49009

REVISIONS
SITE PLAN SURMITTAL 95/02/201
ISSUED FOR BIDS 95/16/201
OSHTEMO COMMENTS 95/23/201

ISSUED

MAY 23, 2019

PROJECT NUMBER

SHEET TITLE

LANDSCAPE PLAN


1 .

express authorization from the architect.

CONST. DOCUMENTS

This drawing, as an instrument of service, is owned by the diekema hamann architecture, inc.
Reproduction of this document is prohibited without


2019 DIEKEMAJHAMANN ARCHITECTURE

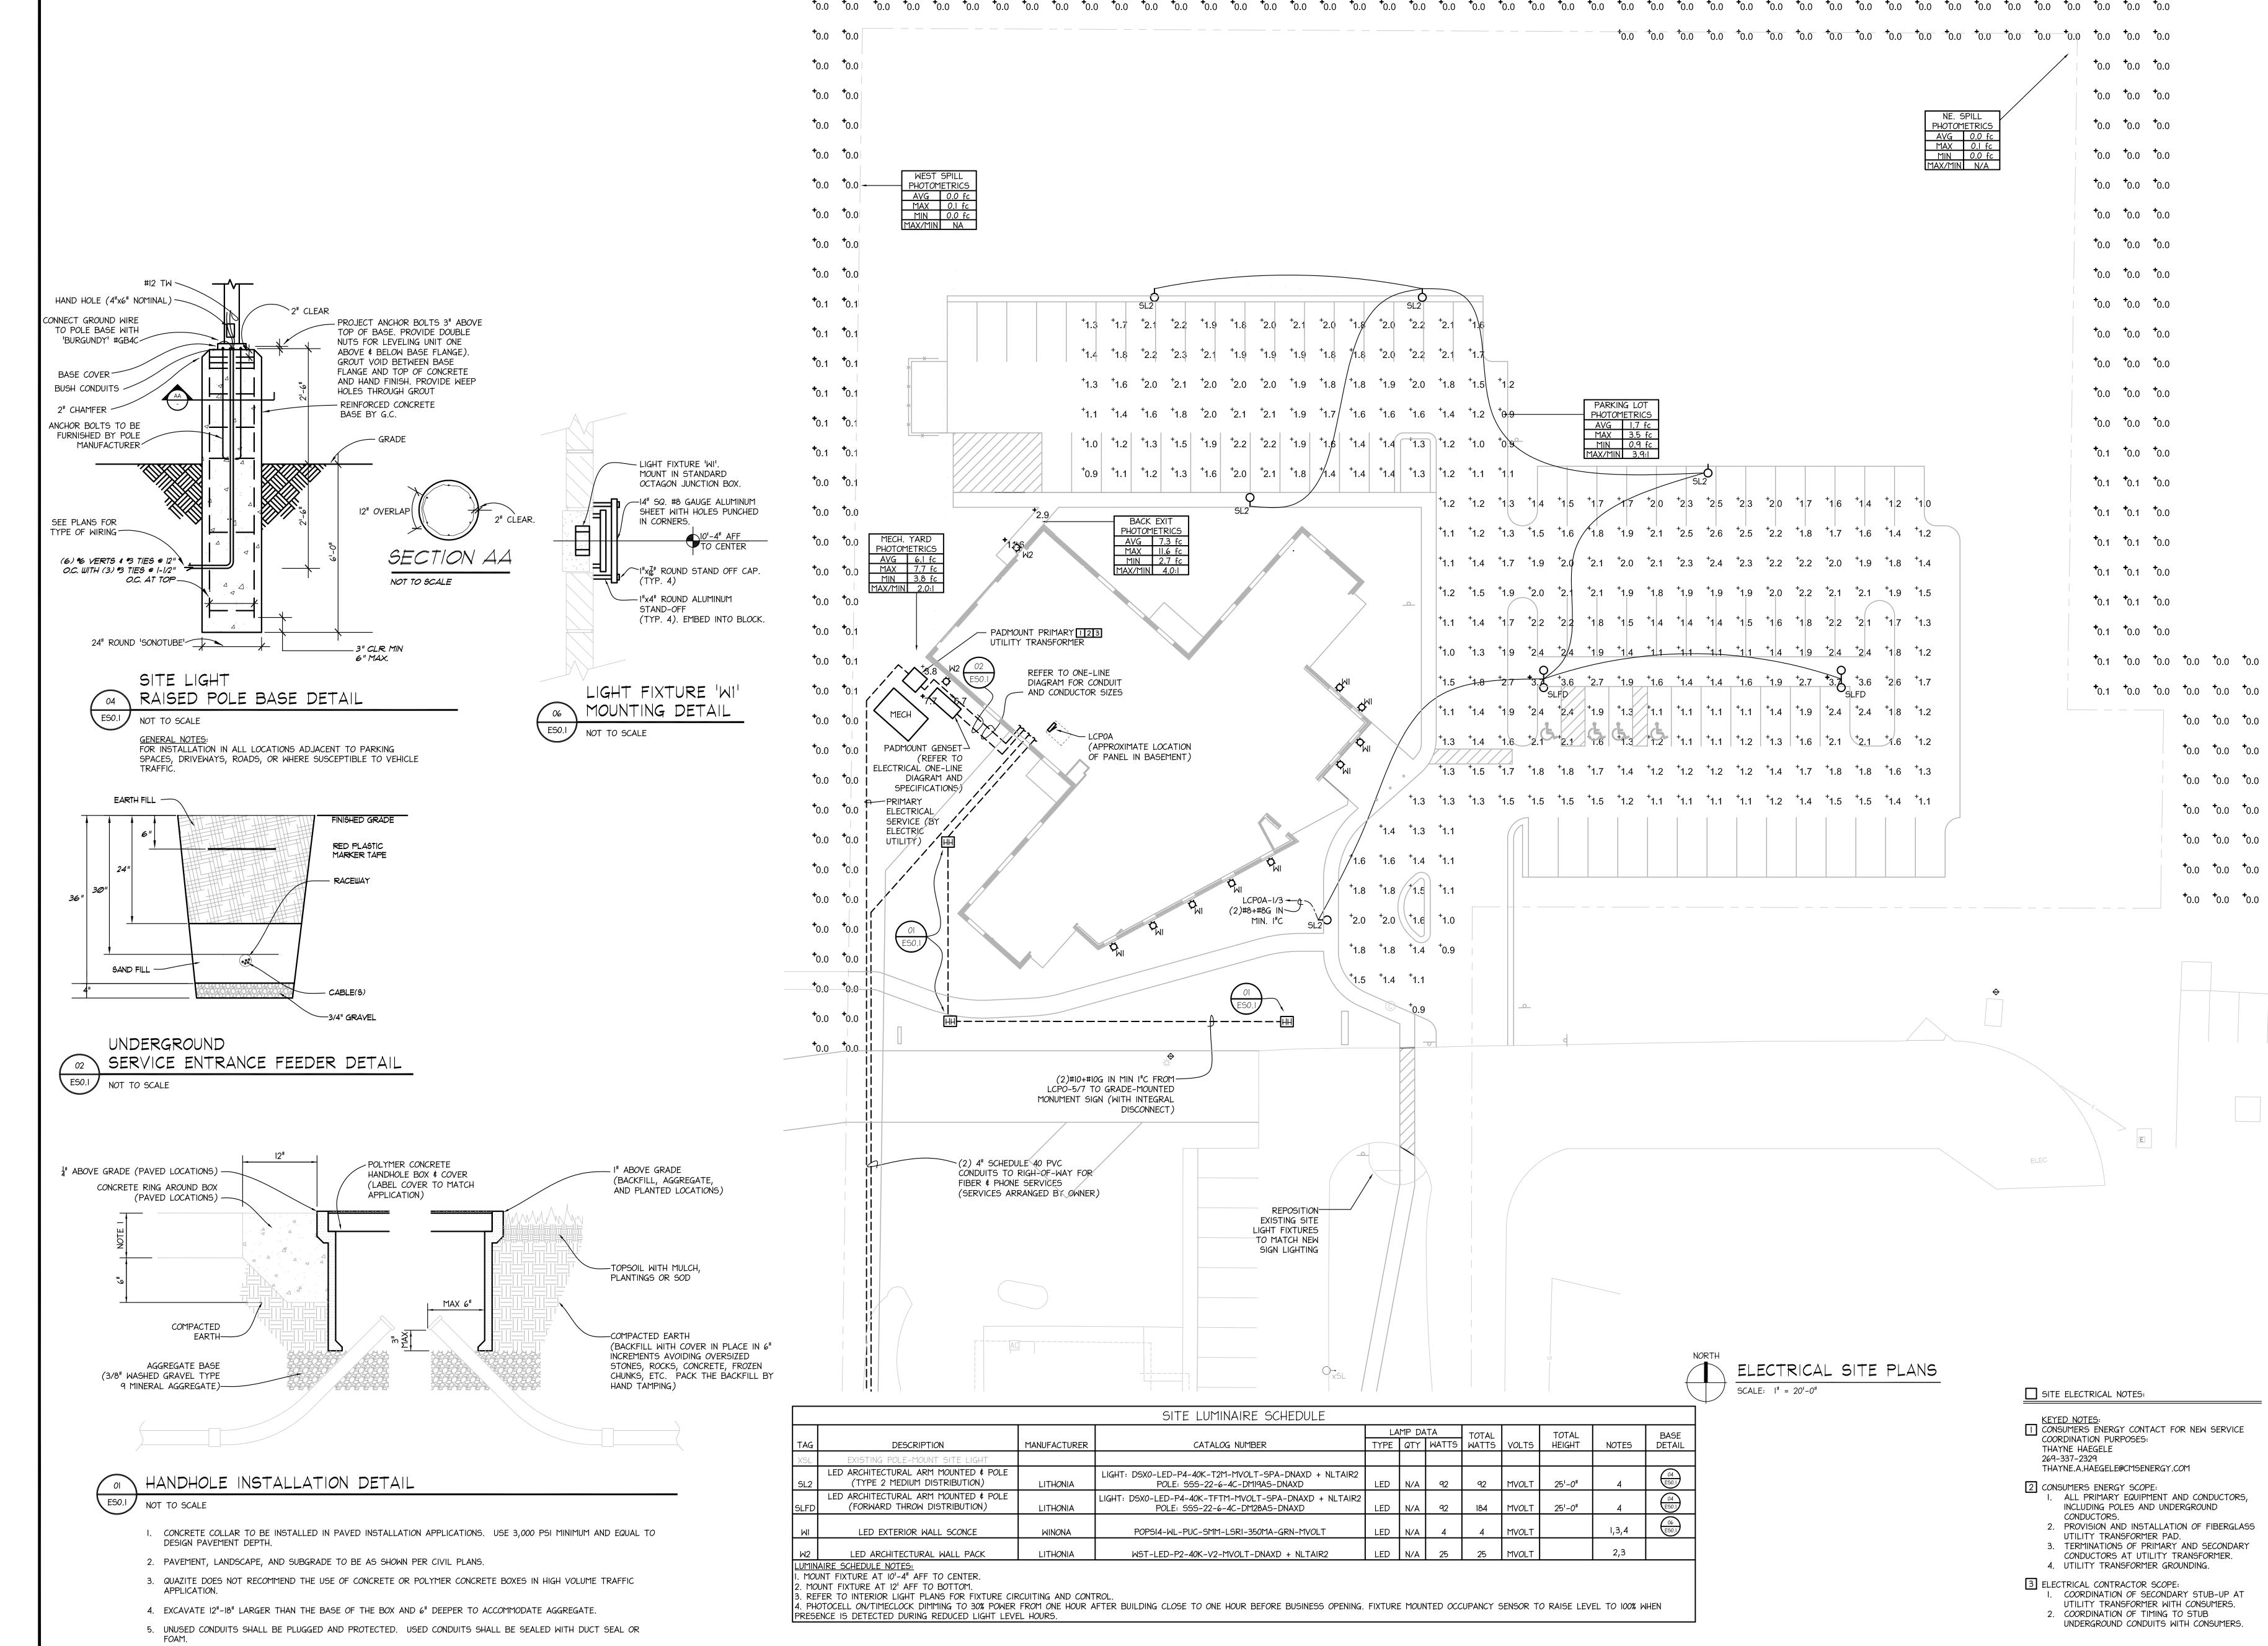

KALAMAZOO : GRAND RAPIDS : 269.373.1108 : www.dhae.cor

KALAMAZOO OFFICE 612 South Park Street Kalamazoo, Michigan 49007

GRAND RAPIDS OFFICE 15 Ionia SW - Suite 330 Grand Rapids, Michigan 49503

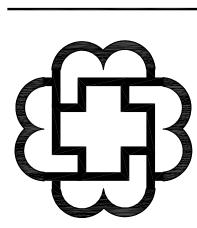

PLAN PLAN NORTH

ALL PLANS, ELEVATIONS,
SCHEDULES, ETC. REFERENCE
PLAN NORTH. ACTUAL
BUILDING ORIENTATION ON
THE "TRUE NORTH"
DIFFERS FROM THE
DRAWING PLAN NORTH.
REFER TO COVER SHEET AND
SITE PLAN FOR TRUE
ORIENTATION OF THE
BUILDING ON THE SITE.

N ST. - NEW PRIMARY CARE BUILDING
NO SON HEALTHCARE GROUF
10 TOWNSHIP, MICHIGAN 49009

REVISIONS

01 - RE-SUBMISSION - 2019.05.23

ISSUED

MAY 16, 2019

PROJECT NUMBER

19015.01

ELECTRICAL SITE PLANS

ESO.1

CONST. DOCUMENTS


This drawing, as an instrument of service, is owned by the diekema hamann architecture, inc.
Reproduction of this document is prohibited without

© 2019 DIEKEMAJHAMANN ARCHITECTURE


express authorization from the architect.





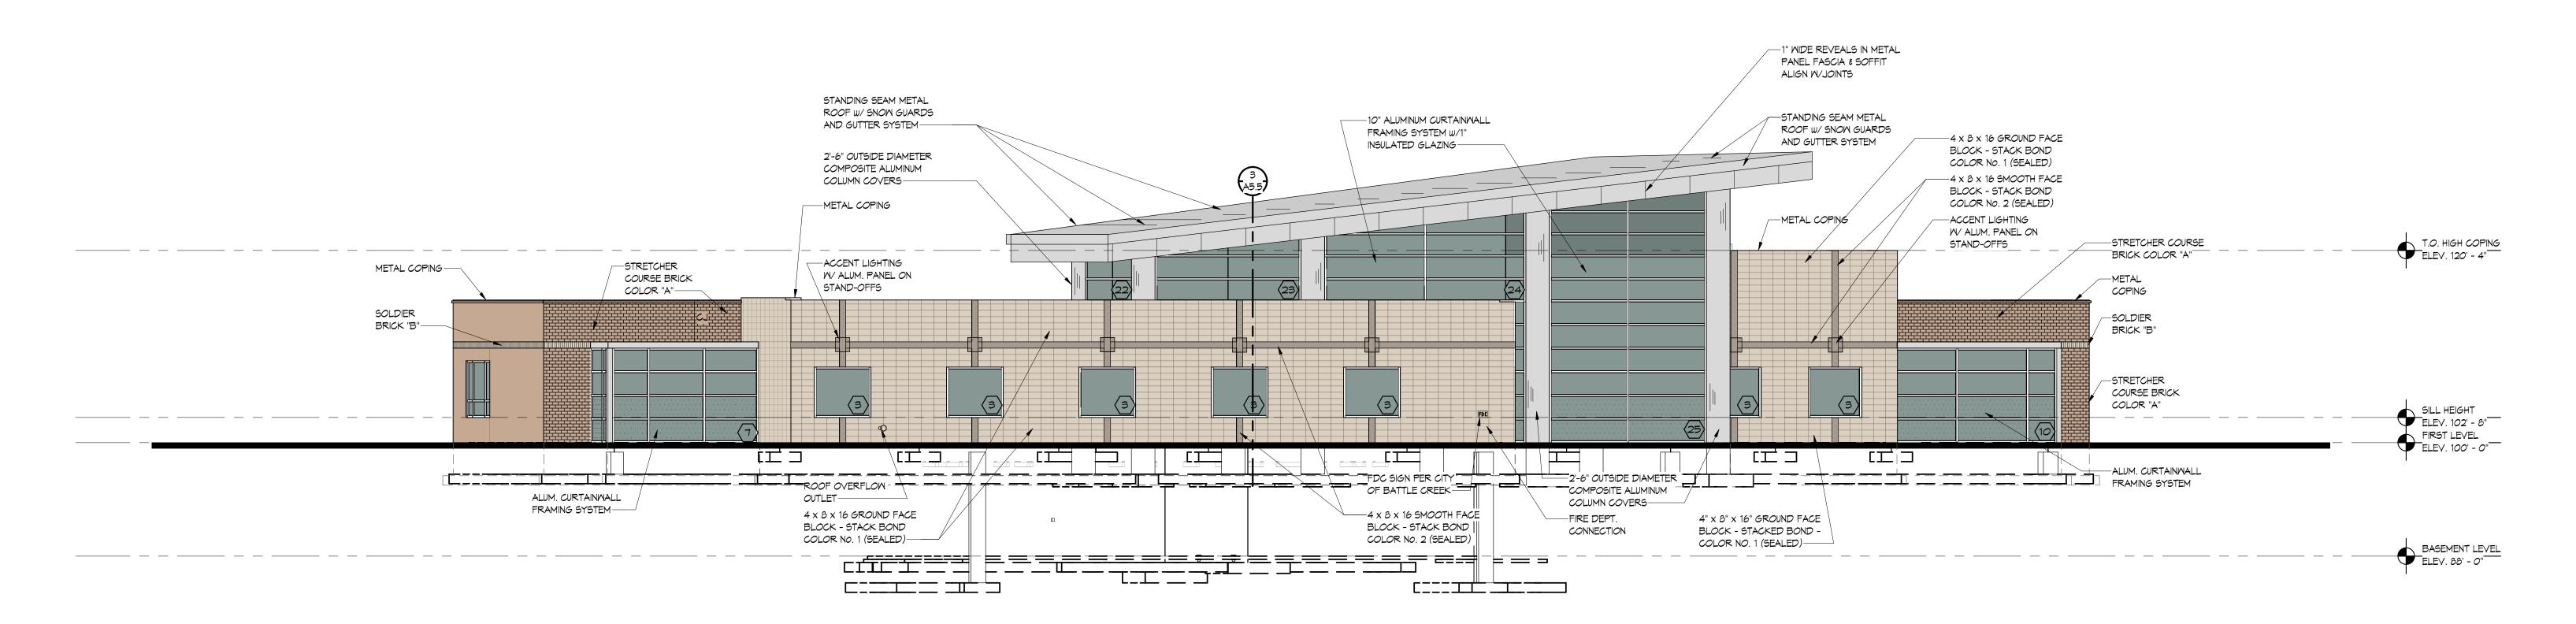

2 NORTHEAST ELEVATION
A3.1 SCALE: 1/8" = 1'-0"

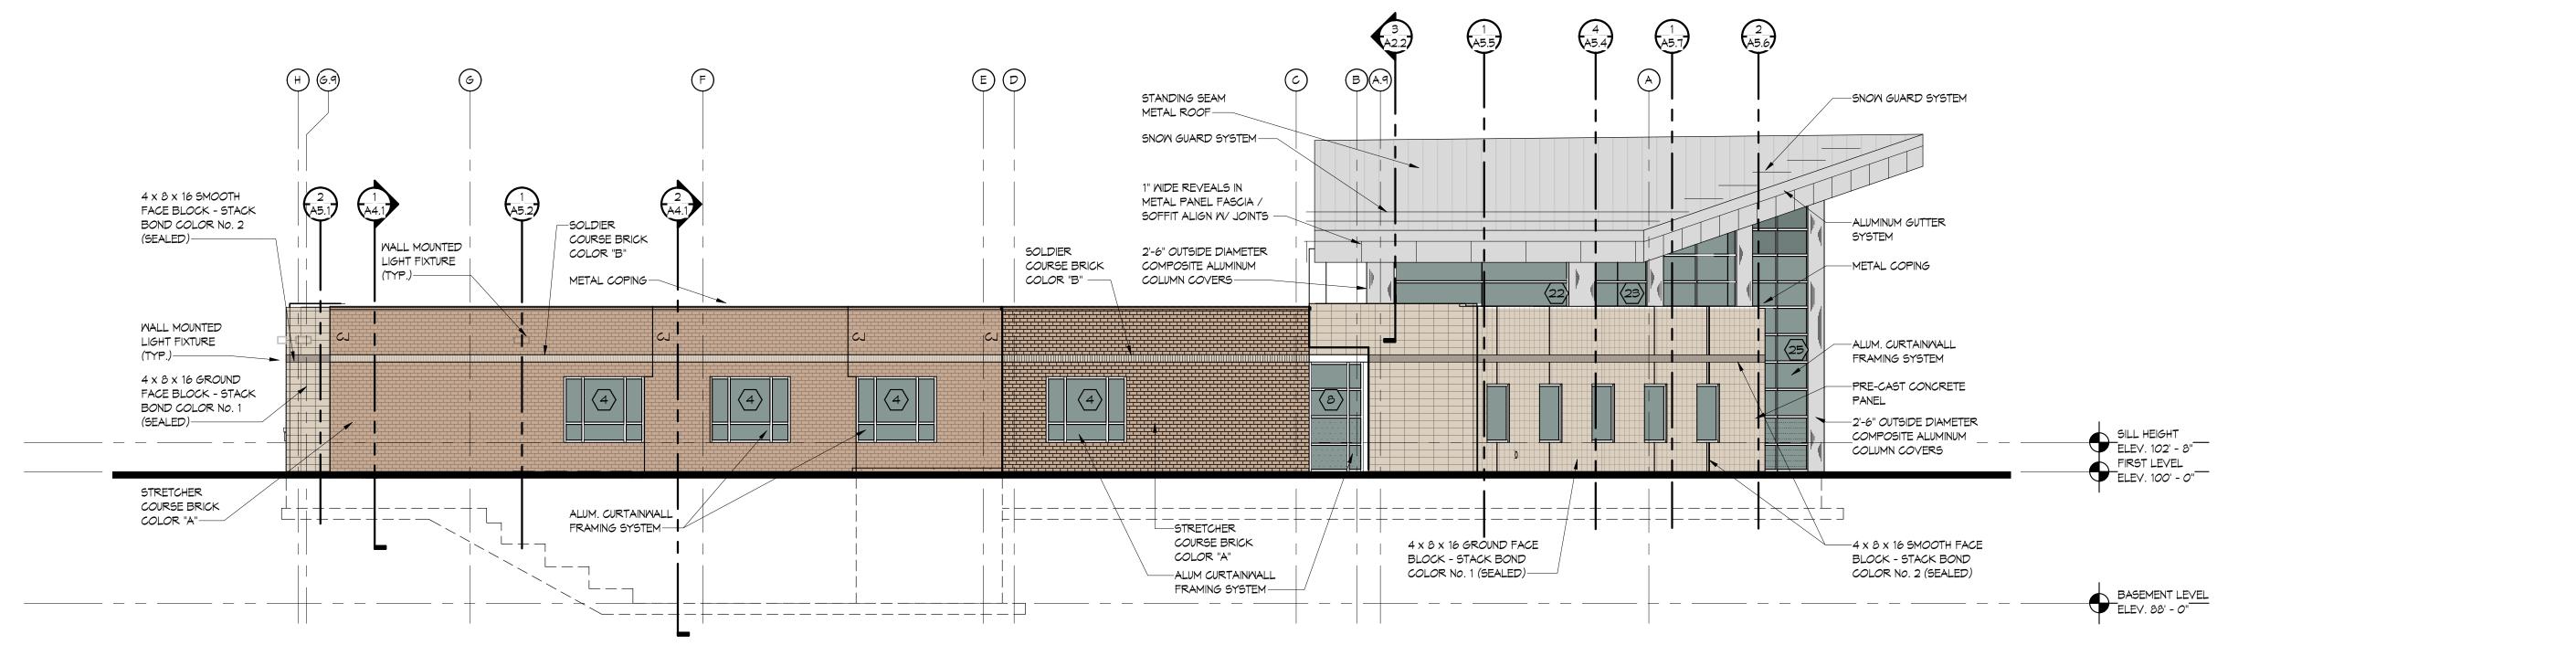


1 EAST ELEVATION
A3.1 SCALE: 1/8" = 1'-0"

KALAMAZOO : GRAND RAPIDS : 269.373.1108 : www.dhae.com

KALAMAZOO OFFICE 612 South Park Street Kalamazoo, Michigan 49007

GRAND RAPIDS OFFICE 15 Ionia SW - Suite 330 Grand Rapids, Michigan 49503



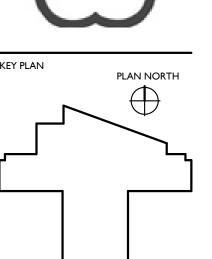

ALL PLANS, ELEVATIONS,
SCHEDULES, ETC. REFERENCE
PLAN NORTH. ACTUAL
BUILDING ORIENTATION ON
THE SITE "TRUE NORTH"
DIFFERS FROM THE
DRAWING PLAN NORTH.
REFER TO COVER SHEET AND
SITE PLAN FOR TRUE
ORIENTATION OF THE
BUILDING ON THE SITE.

W. MAIN ST. – NEW PRIMARY CARE BUILDING

BRONSON HEALTHCARE GROUF

OSHTEMO TOWNSHIP, MICHIGAN 49009

EVISIONS

MAY 2, 2019

PROJECT NUMBER


EXTERIOR ELEVATIONS


SHEET NUMBER

A3.1

This drawing, as an instrument of service, is owned by the diekema hamann architecture, inc.
Reproduction of this document is prohibited without express authorization from the architect.

© 2019 DIEKEMA|HAMANN ARCHITECTURE

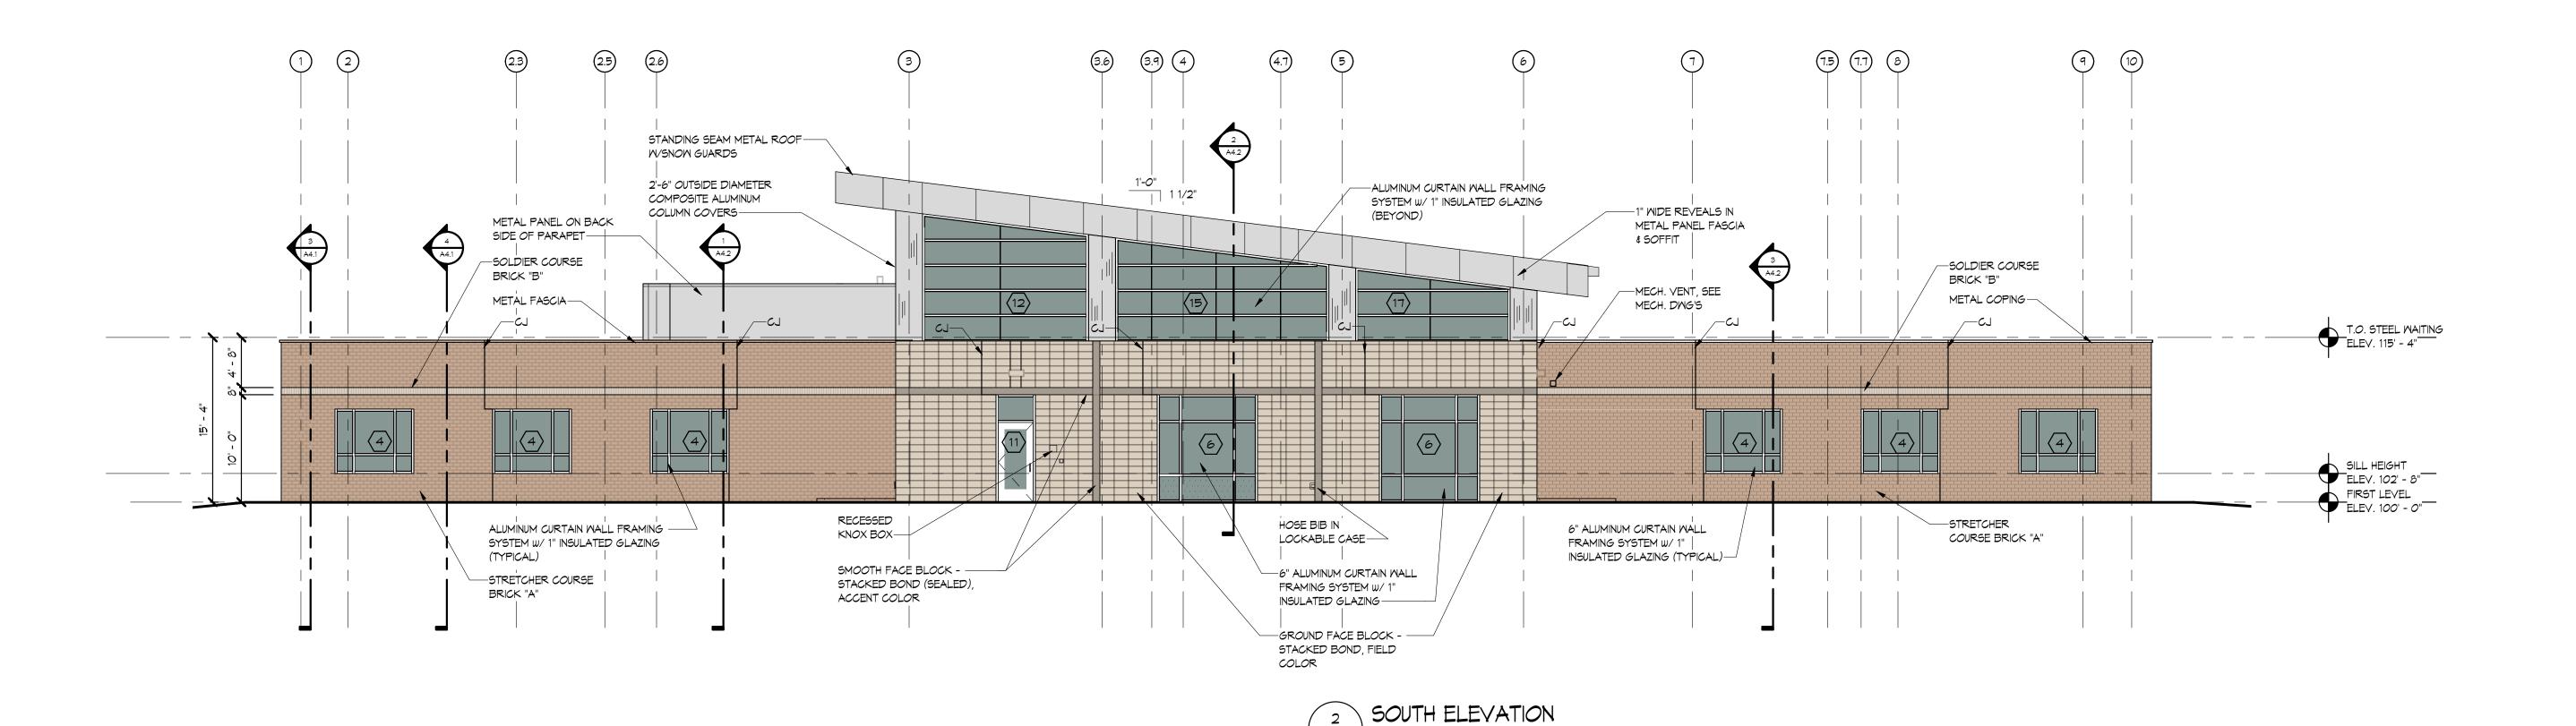

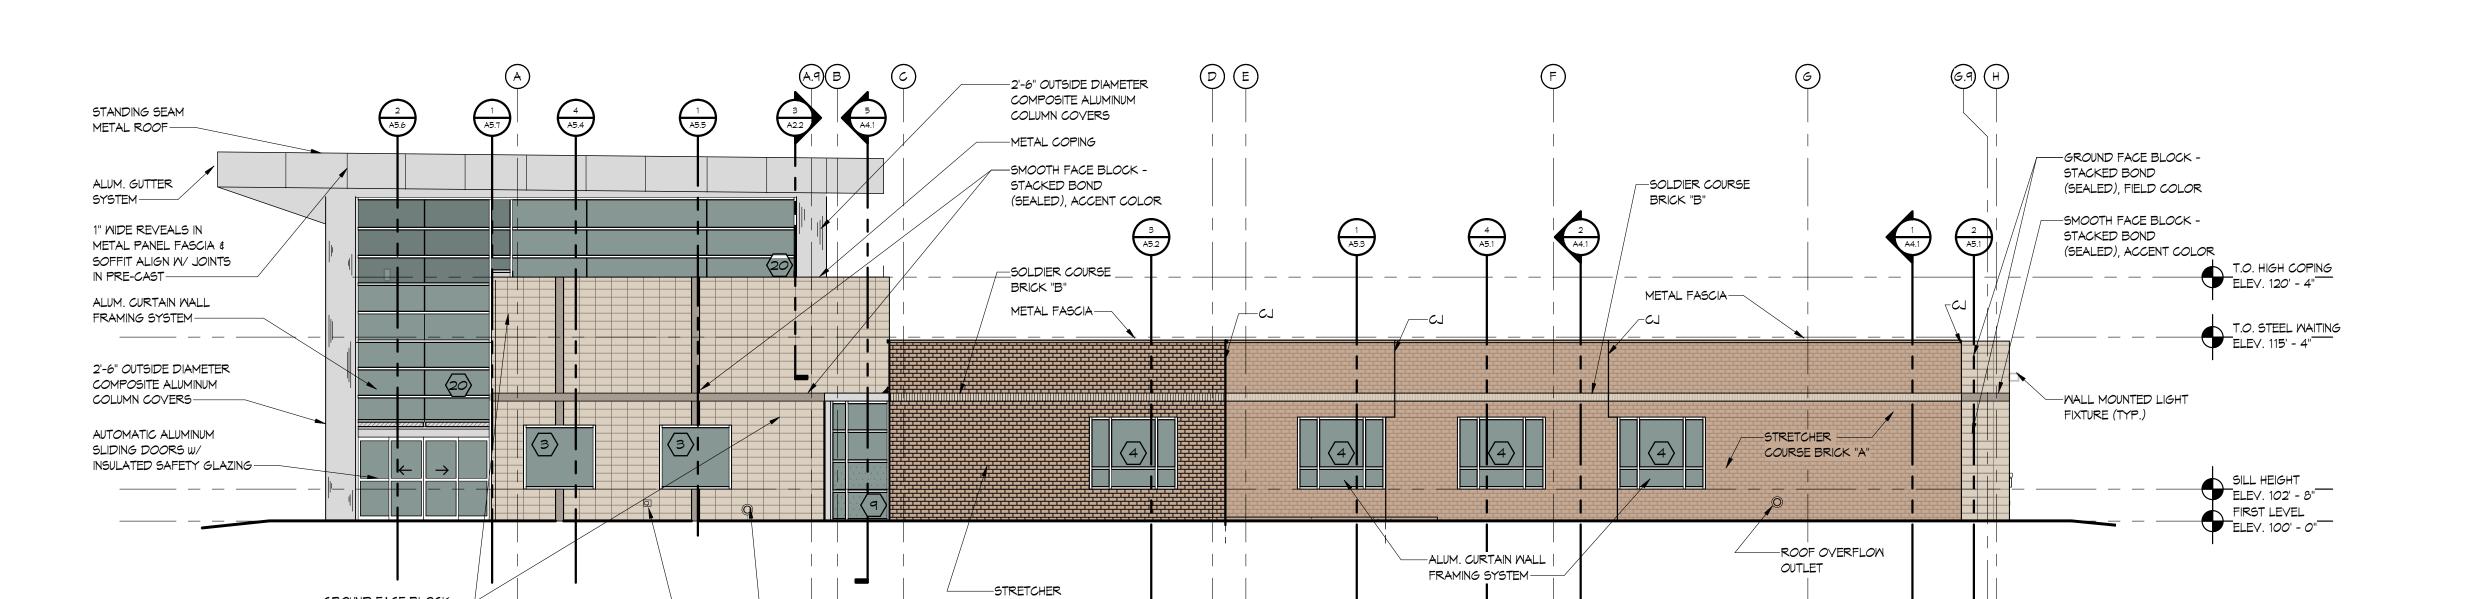

A3.2 | SCALE: 1/8" = 1'-0"

1 WEST ELEVATION
A3.2 SCALE: 1/8" = 1'-0"

COURSE BRICK

-ROOF OVERFLOW

OUTLET

GROUND FACE BLOCK - STACKED BOND

(SEALED), FIELD COLOR


HOSE BIB IN


LOCKABLE CASE-



KALAMAZOO OFFICE 612 South Park Street Kalamazoo, Michigan 49007

GRAND RAPIDS OFFICE 15 Ionia SW - Suite 330 Grand Rapids, Michigan 49503

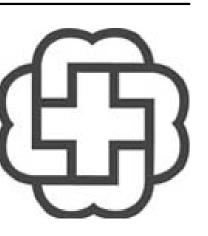

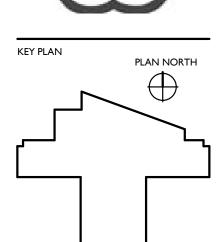

ALL PLANS, ELEVATIONS, SCHEDULES, ETC. REFERENCE PLAN NORTH. ACTUAL BUILDING ORIENTATION ON THE SITE "TRUE NORTH" DIFFERS FROM THE DRAWING PLAN NORTH. REFER TO COVER SHEET AND SITE PLAN FOR TRUE ORIENTATION OF THE BUILDING ON THE SITE.

W. MAIN ST. – NEW PRIMARY CARE BUILDING

BRONSON HEALTHCARE GROU

OSHTEMO TOWNSHIP, MICHIGAN 49009

ISSUED

MAY 16, 2019
PROJECT NUMBER

19015.01

EXTERIOR ELEVATIONS

A3.2

This drawing, as an instrument of service, is owned by the diekema hamann architecture, inc.
Reproduction of this document is prohibited without express authorization from the architect.

© 2019 DIEKEMA|HAMANN ARCHITECTURE

CONST. DRAWINGS